


THORNWELL 2ND FLOOR RENOVATIONS

PROJECT NUMBER: H27 - Z002

CONTRACT NO. CP00343152/FM00392260

UNIVERSITY OF SOUTH CAROLINA COLUMBIA, SOUTH CAROLINA

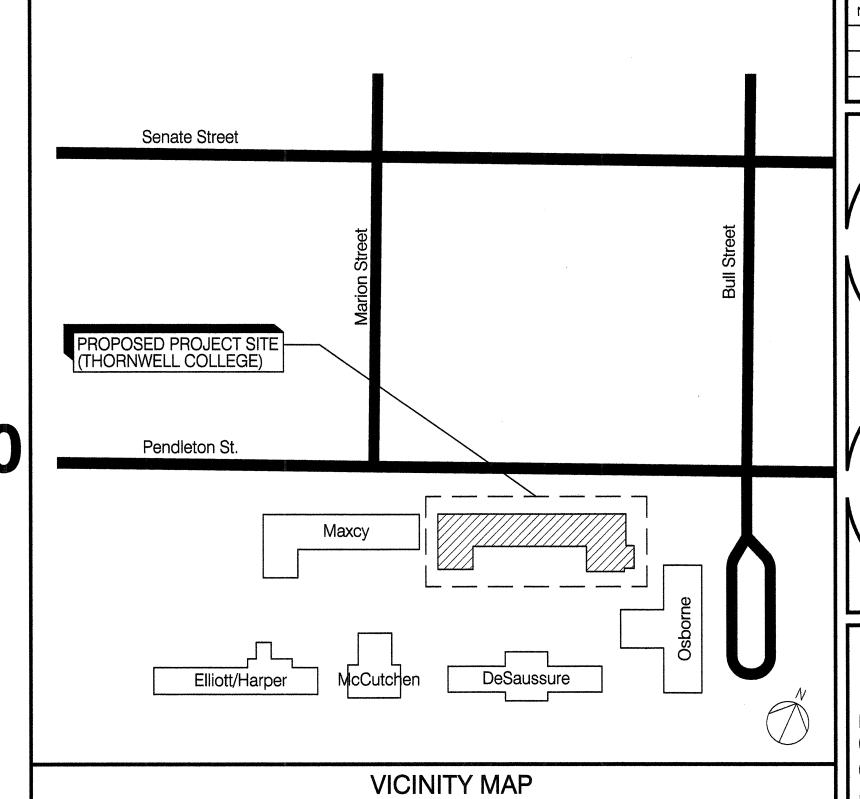

Architect

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Mechanical Engineering

SWYGERT & Associates P.O. Box 11686 Columbia, SC 29211 p | 803.791.9300

KEY SYMBOLS SCOPE OF WORK **ABBREVIATIONS INDEX OF DRAWINGS** SHEET # SHEET NAME THE FOLLOWING IS A GENERAL OVERVIEW OF THE SCOPE OF WORK FOR THE PROPOSED RENOVATION TO THE 2ND FLOOR THORNWELL COLLEGE. THE CONTRACTOR SHALL BE RESPONSIBLE FOR COORDINATING WITH CO-1 **COVER SHEET** APPROPRIATE BUILDING OFFICIALS AND THE OWNER AS REQUIRED TO COMPLETE THE ENTIRE PROJECT AS DESCRIBED AT NO ADDITIONAL COST TO OWNER: ARCHITECTURAL DRAWINGS BOARD JOINT 1. THE OVERALL SCOPE OF THE WORK INCLUDES RENOVATING APPROXIMATELY 1,307 SF ON THE 2ND FLOOR LIFE SAFETY PLAN AND CODE ANALYSIS AND MISCELLANEOUS DETAILS BUILDING M.O. BLDG. MASONRY OPENING OF THORNWELL COLLEGE INTO 5 OFFICES AND A WORK ROOM. ALSO INCLUDED IN THE SCOPE OF WORK IS SECTION NUMBER OR LETTER TO CONVERT THE EXISTING WORK ROOM 234 INTO AN OFFICE SPACE. REMOVE AND REINSTALL WALL CENTER LINE MAX. MAXIMUM BUILDING AND A100 EXISTING 2ND FLOOR OVERALL FLOOR PLAN AND 1ST FLOOR RENOVATION PLAN MATERIALS ON THE 1ST FLOOR AS REQUIRED TO INSTALL NEW STRUCTURAL COLUMNS. MECH. CONTROL JOINT MECHANICAL WALL SECTION SHEET WHERE DRAWN CEIL MTL DEMOLITION, RENOVATION AND REFLECTED CEILING FLOOR PLANS AND MISCELLANEOUS DETAILS CEILING 2. PROVIDE DEMOLITION WORK AS SHOWN, INCLUDING REMOVAL OF EXISTING PARTITIONS, CEILINGS, C.T. MINIMUM CERAMIC TILE FLOORING, & LIGHT FIXTURES, HVAC UNIT AND DUCTWORK AS SHOWN. SALVAGE EXISTING DOORS, ROOM FINISH AND DOOR SCHEDULES AND MISCELLANEOUS DETAILS C.G. CORNER GUARD NOT APLICABLE FRAMES, HVAC EQUIPMENT AND LIGHT FIXTURES FOR REUSE AS INDICATED. CMU CONCRETE MASONRY UNIT N.I.C. NOT IN CONTRACT N.T.S. COMP. NOT TO SCALE COMPOSITE 3. CONSTRUCT NEW WALL AND PARTITIONS AS SHOWN. PROVIDE NEW FLOOR, CEILINGS AND WALL FINISHES ELEVATION NUMBER BUILDING AND O.C. COL. COLUMN ON CENTER AS SHOWN. PAINT ALL WALLS AND DOORS AS INDICATED. STRUCTURAL **ELEVATION** (A2) O.H. CONT CONTINUOUS OPPOSITE HAND SHEET WHERE DRAWN 4. INSTALL NEW LIGHTING, POWER, HVAC, DUTWORK, ETC. AS SHOWN. REUSE EXISTING ITEMS WHEN CPT. CARPET PLANS & NOTES DET. PLAS. LAM. DETAIL PLASTIC LAMINATE **DETAILS** S-2 DIA. DIAMETER RES. RESILIENT CONTRACTOR SHALL BE RESPONSIBLE FOR COORDINATING AND INSTALLING ALL WORK AS SHOWN. NOTE DN. REQD. REQUIRED THE BUILDING WILL BE OCCUPIED THORUGHOUT THE DURATION OF THE WORK. CONTRACTOR SHALL BE DETAILNUMBER PLAN OR SECTION R.D. DBL. DOUBLE ROOF DRAIN RESPONSIBLE FOR COORDINATING ANY POWER AND/OR UTILITY OUTAGES AS REQUIRED TO MINIMIZE A2 / DWG. ROOF LEADER **DRAWING** SHEET WHERE DRAWN **MECHANICAL DRAWINGS** DISRUPTION TO OTHER PORTIONS OF THE BUILDING. SHEET E.J. **EXPANSION JOINT** SIM. MECHANICAL PLAN ELEC. SIMILAR ELECTRICAL S.C. ELEV. **ELEVATOR OR ELEVATION** SOLID CORE EQ. SQ. FT. REFERS TO NUMBER ELECTRIC WATER COOLER E.W.C. S.S. STAINLESS STEEL **ELECTRICAL DRAWINGS** ROOM NUMBER ON FLOOR PLAN EXT. STRUCT. **EXTERIOR** FINISH FLOOR SUSPENDED ELECTRICAL DEMOLITION AND RENOVATION PLANS F.E. T.O.() TOP OF (ITEM) FIRE EXTINGUISHER F.E.C. TYP. FIRE EXTINGUISHER CABINET TYPICAL F.D. VERT. FLOOR DRAIN VERTICAL GA. V.C.T. GAUGE GYPSUM WALL BOARD GWB. V.W.C. WD. HW. WOOD HARD WOOD H.C. HOLLOW CORE

SQUARE FEET (FOOT) STRUCTURE OR STRUCTURAL VINYL COMPOSITION TILE VINYL WALL COVERING

COLUMBIA, SC


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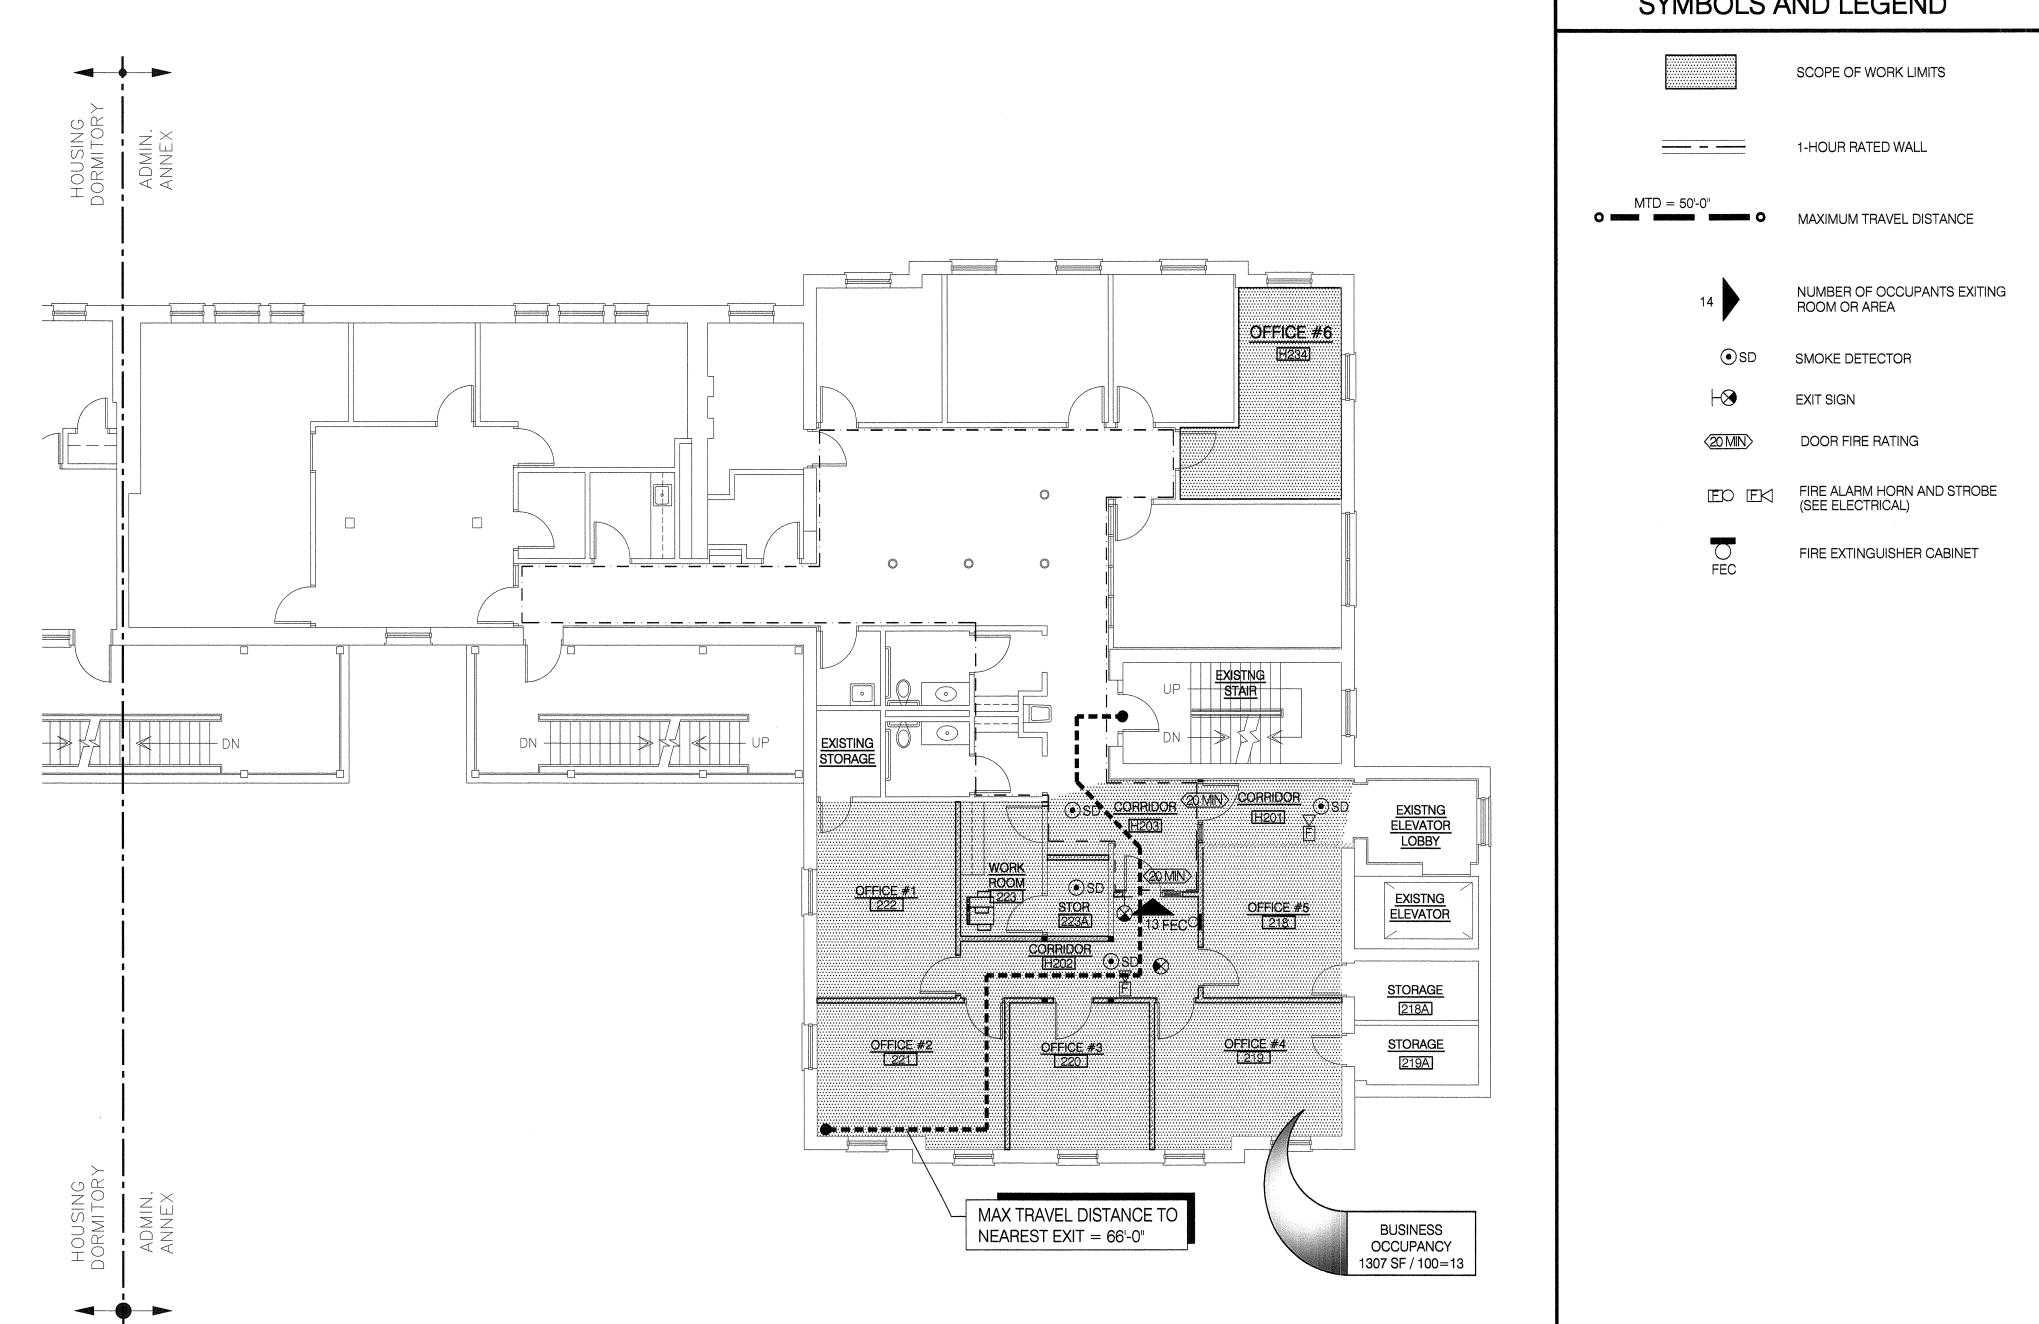
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PAGE NAME **COVER PAGE**

DESIGNED BY: JB DRAWN BY: CC/LD CHECKED BY: JB DATE: 07/18/2012 SCALE: AS NOTED JOB NO.: HED-12-1002





PARTIAL SECOND FLOOR - LIFE SAFETY PLAN

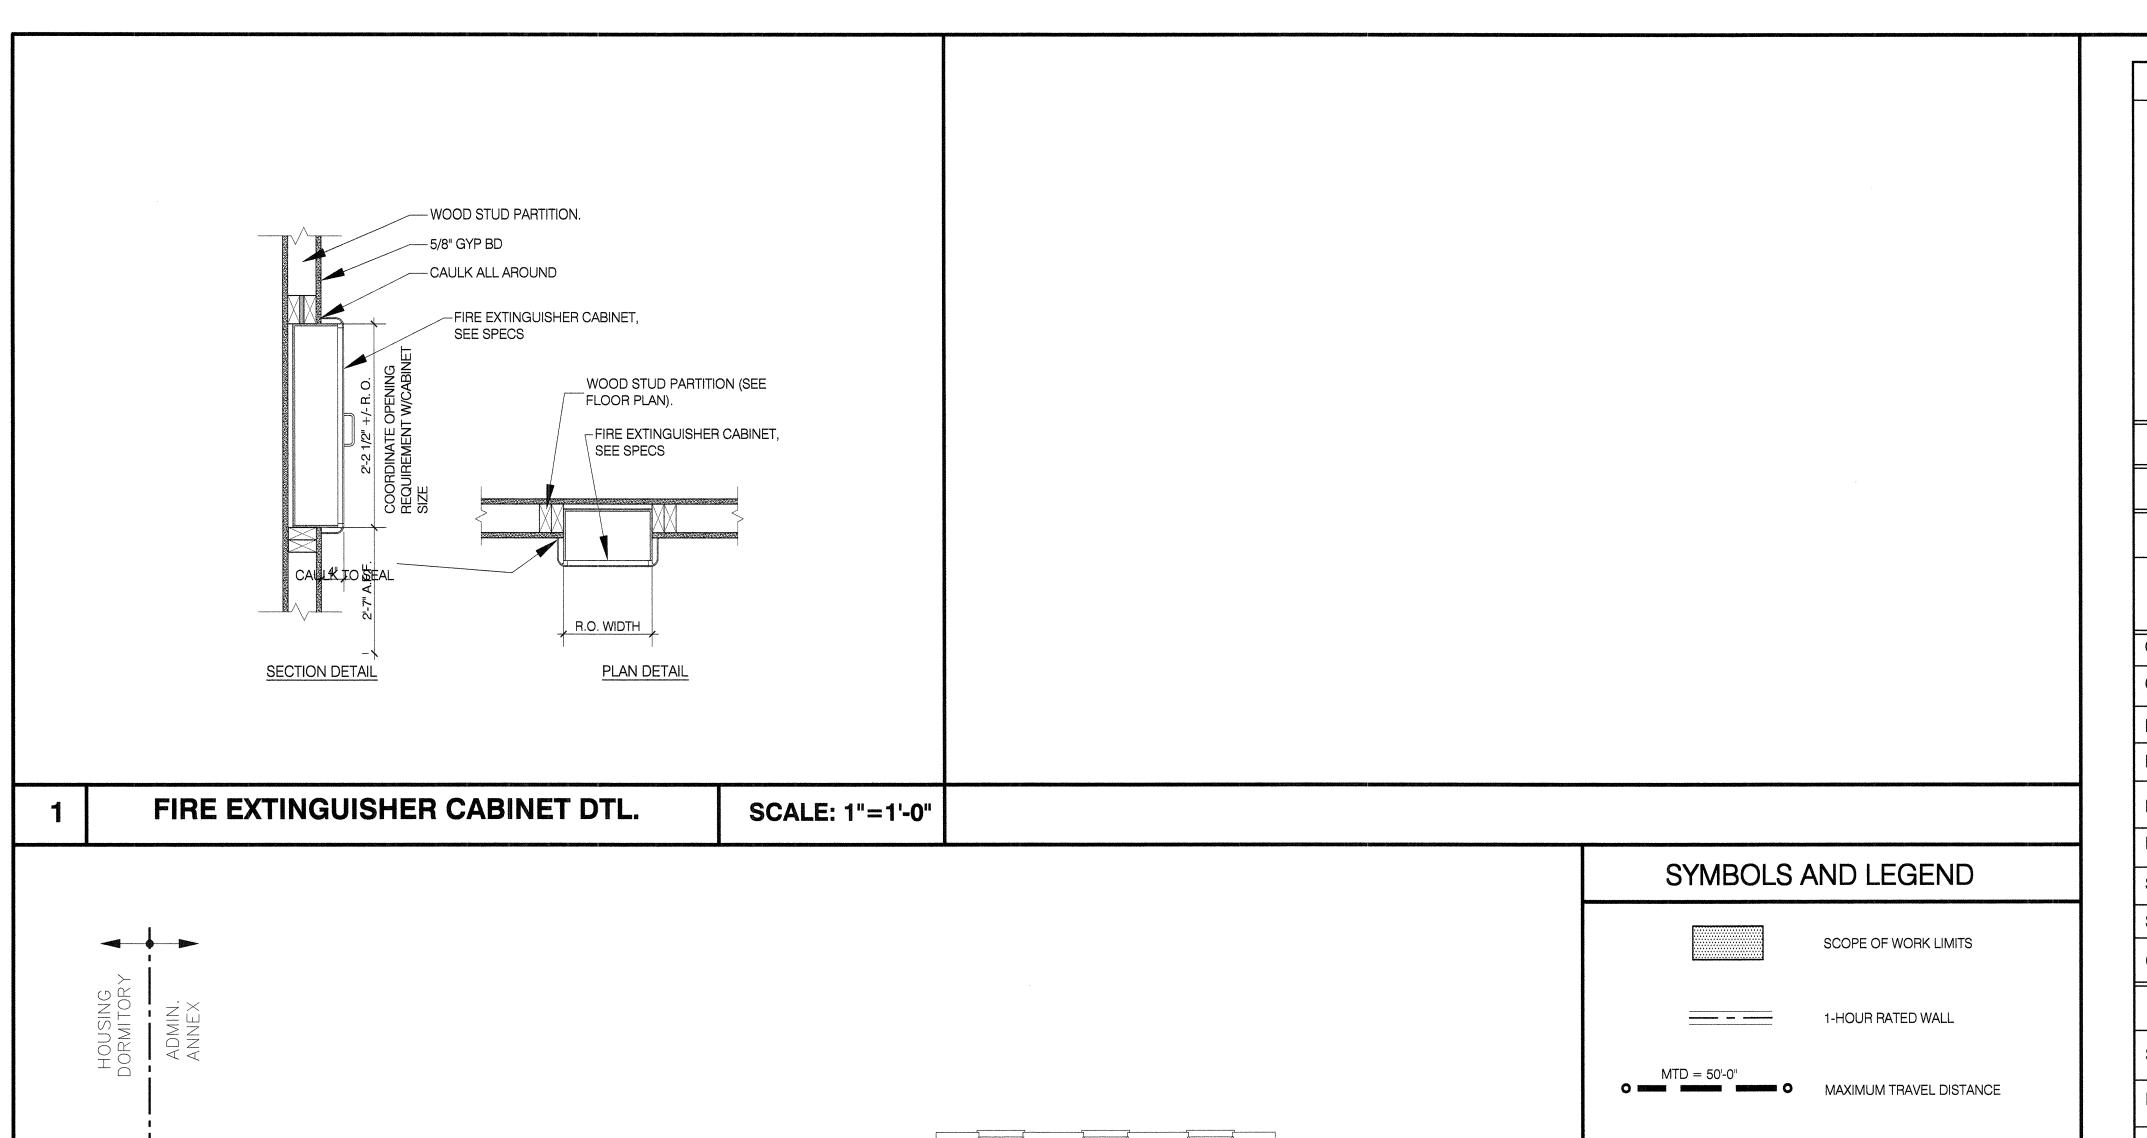BUILDING CODE ANALYSIS

THIS PROJECT IS DESIGNED IN ACCORDANCE WITH

- 1. International Existing Building Code 2009 EDITION
- 1. International Building Code 2009 EDITION
- 2. International Fire Code 2009 Edition
- 3. International Fuel Gas Code 2009 Edition
- 4. International Mechanical Code 2009 Edition 5. International Plumbing Code - 2009 Edition
- 6. ICC Electrical Code, Admnistrative Provisions, Adminitrative Provisions, ICCEC 2009 Edition
- 7. National Electrical Code, NFPA 70. Latest Edition
- 8. National Electrical Safety Code, ANSI C2 Latest Edition
- 9. ICC/ANSI A117.1 Accesible and Usable Buildings and Facilities, Latest Edition

FLOOD HAZARD INFORMATION and FLOOD LOADS (NOT APPLICABLE)

SOILS AND SITE INFORMATION (NOT APPLICABLE)

BASIC CODE REVIEW INFORMATION

CODE ITEM	CODE	DESIGNATION APPLIED				
OODL ITLIVI	REFERENCE	EXISTING 2ND FL	PROPOSED 2ND FL RENOVATION			
OCCUPANCY CLASSIFICATION	CHAPTER 3	BUSINESS	BUSINESS			
CONSTRUCTION CLASSIFICATION	CHAPTER 6	TYPE IIIA	TYPE IIIA			
BUILDING HEIGHT ALLOWED	CHAPTER 5 TABLE 503	65'-0"	NA			
BUILDING HEIGHT AS DESIGNED		45'-0"	NA .			
BUILDING AREA ALLOWED		28,500 SQ. FT.	28,500 SQ. FT.			
BUILDING AREA AS DESIGNED		12,348 SQ. FT.	1,307 SQ. FT.			
STORIES ALLOWED		5	NA			
STORIES AS DESIGNED		3	3			
OCCUPANT LOAD		VARIES	1,307 / 100 = 13 PEOPLE			
	(Maurice Josephanthalth Commission Spottenthios, agus ann an an agus ghailteach ann an an Aideann an ann ann a					

STRUCTURAL MEMBERS

31 NOCTORAL MEMBERS	STRUCTURAL MILIMBERS						
STRUCTURAL FRAME	CHAPTER 6 TABLE 601	1 HR (EXISTING)	1 HR (IBC TABLE 720.1(1) ITEM # 1-7.1				
EXTERIOR BEARING WALLS	CHAPTER 6 TABLE 601	2 HR (EXISTING)	NOT APPLICABLE				
INTERIOR BEARING WALLS	CHAPTER 6 TABLE 601	1 HR (EXISTING)	1 HR (UL U-305)				
EXTERIOR NON-BEARING WALLS AND PARTITIONS	CHAPTER 6 TABLE 601	1 HR (EXISTING)	NOT APPLICABLE				
INTERIOR NON-BEARING WALLS AND PARTITIONS	CHAPTER 6 TABLE 601	0	0				
FLOOR CONSTRUCTION	CHAPTER 6 TABLE 601	1 HR (EXISTING)	1 HR (GA FILE NO. FC5406)				
ROOF CONSTRUCTION	CHAPTER 6 TABLE 601	1 HR (EXISTING)	NOT APPLICABLE				

SEPARATION WALLS

Other suppression systems required

Smoke & heat vents required

SCALE: 1/8" = 1'-0"

FIRE WALLS	TABLE 706.4	4 HR (EXISTING)	NOT APPLICABLE
OCCUPANCY SEPARATION WALLS	TABLE 508.4	(EXISTING)	NOT APPLICABLE
EXIT STAIR	SECTION 708	1 HR (EXISTING)	NOT APPLICABLE
HORIZONTAL EXIT	SECTION 1025	NOT APPLICABLE	NOT APPLICABLE
EXIT DISCHARGE	SECTION 1027	NOT APPLICABLE	NOT APPLICABLE
EXIT ACCESS CORRIDOR WALLS	TABLE 1018.1	1 HR (EXISTING)	1 HR (UL U-305)
ELEVATOR SHAFTS WALLS	SECTION 708	1 (EXISTING)	NOT APPLICABLE

no Xyes	per IBC Section 717
X no yes	per IBC Section 717
X no yes	per IBC Section 909
X no ☐yes	per IBC Sections 407 and 408
no Xyes	per IBC Section 709
	X no yes X no yes X no yes

GENERAL FIRE PROTECTION REQUIREMENTS FOR RENOVATION PORTION

X no per IBC Section 707 Fire Barrier Required ALARM & DETECTION Fire Alarm System Required no Xyes per IFC Section 907 X no yes per IFC Section 908 Emergency Alarm System Required

SUPPRESSION X no per IBC Section 905 Standpipes Required Sprinklers Required per IBC Sections 903 no X no X no Portable extinguishers required per IFC Sections 906


yes yes

per IFC Section 904

per IFC Section 910

LS-01

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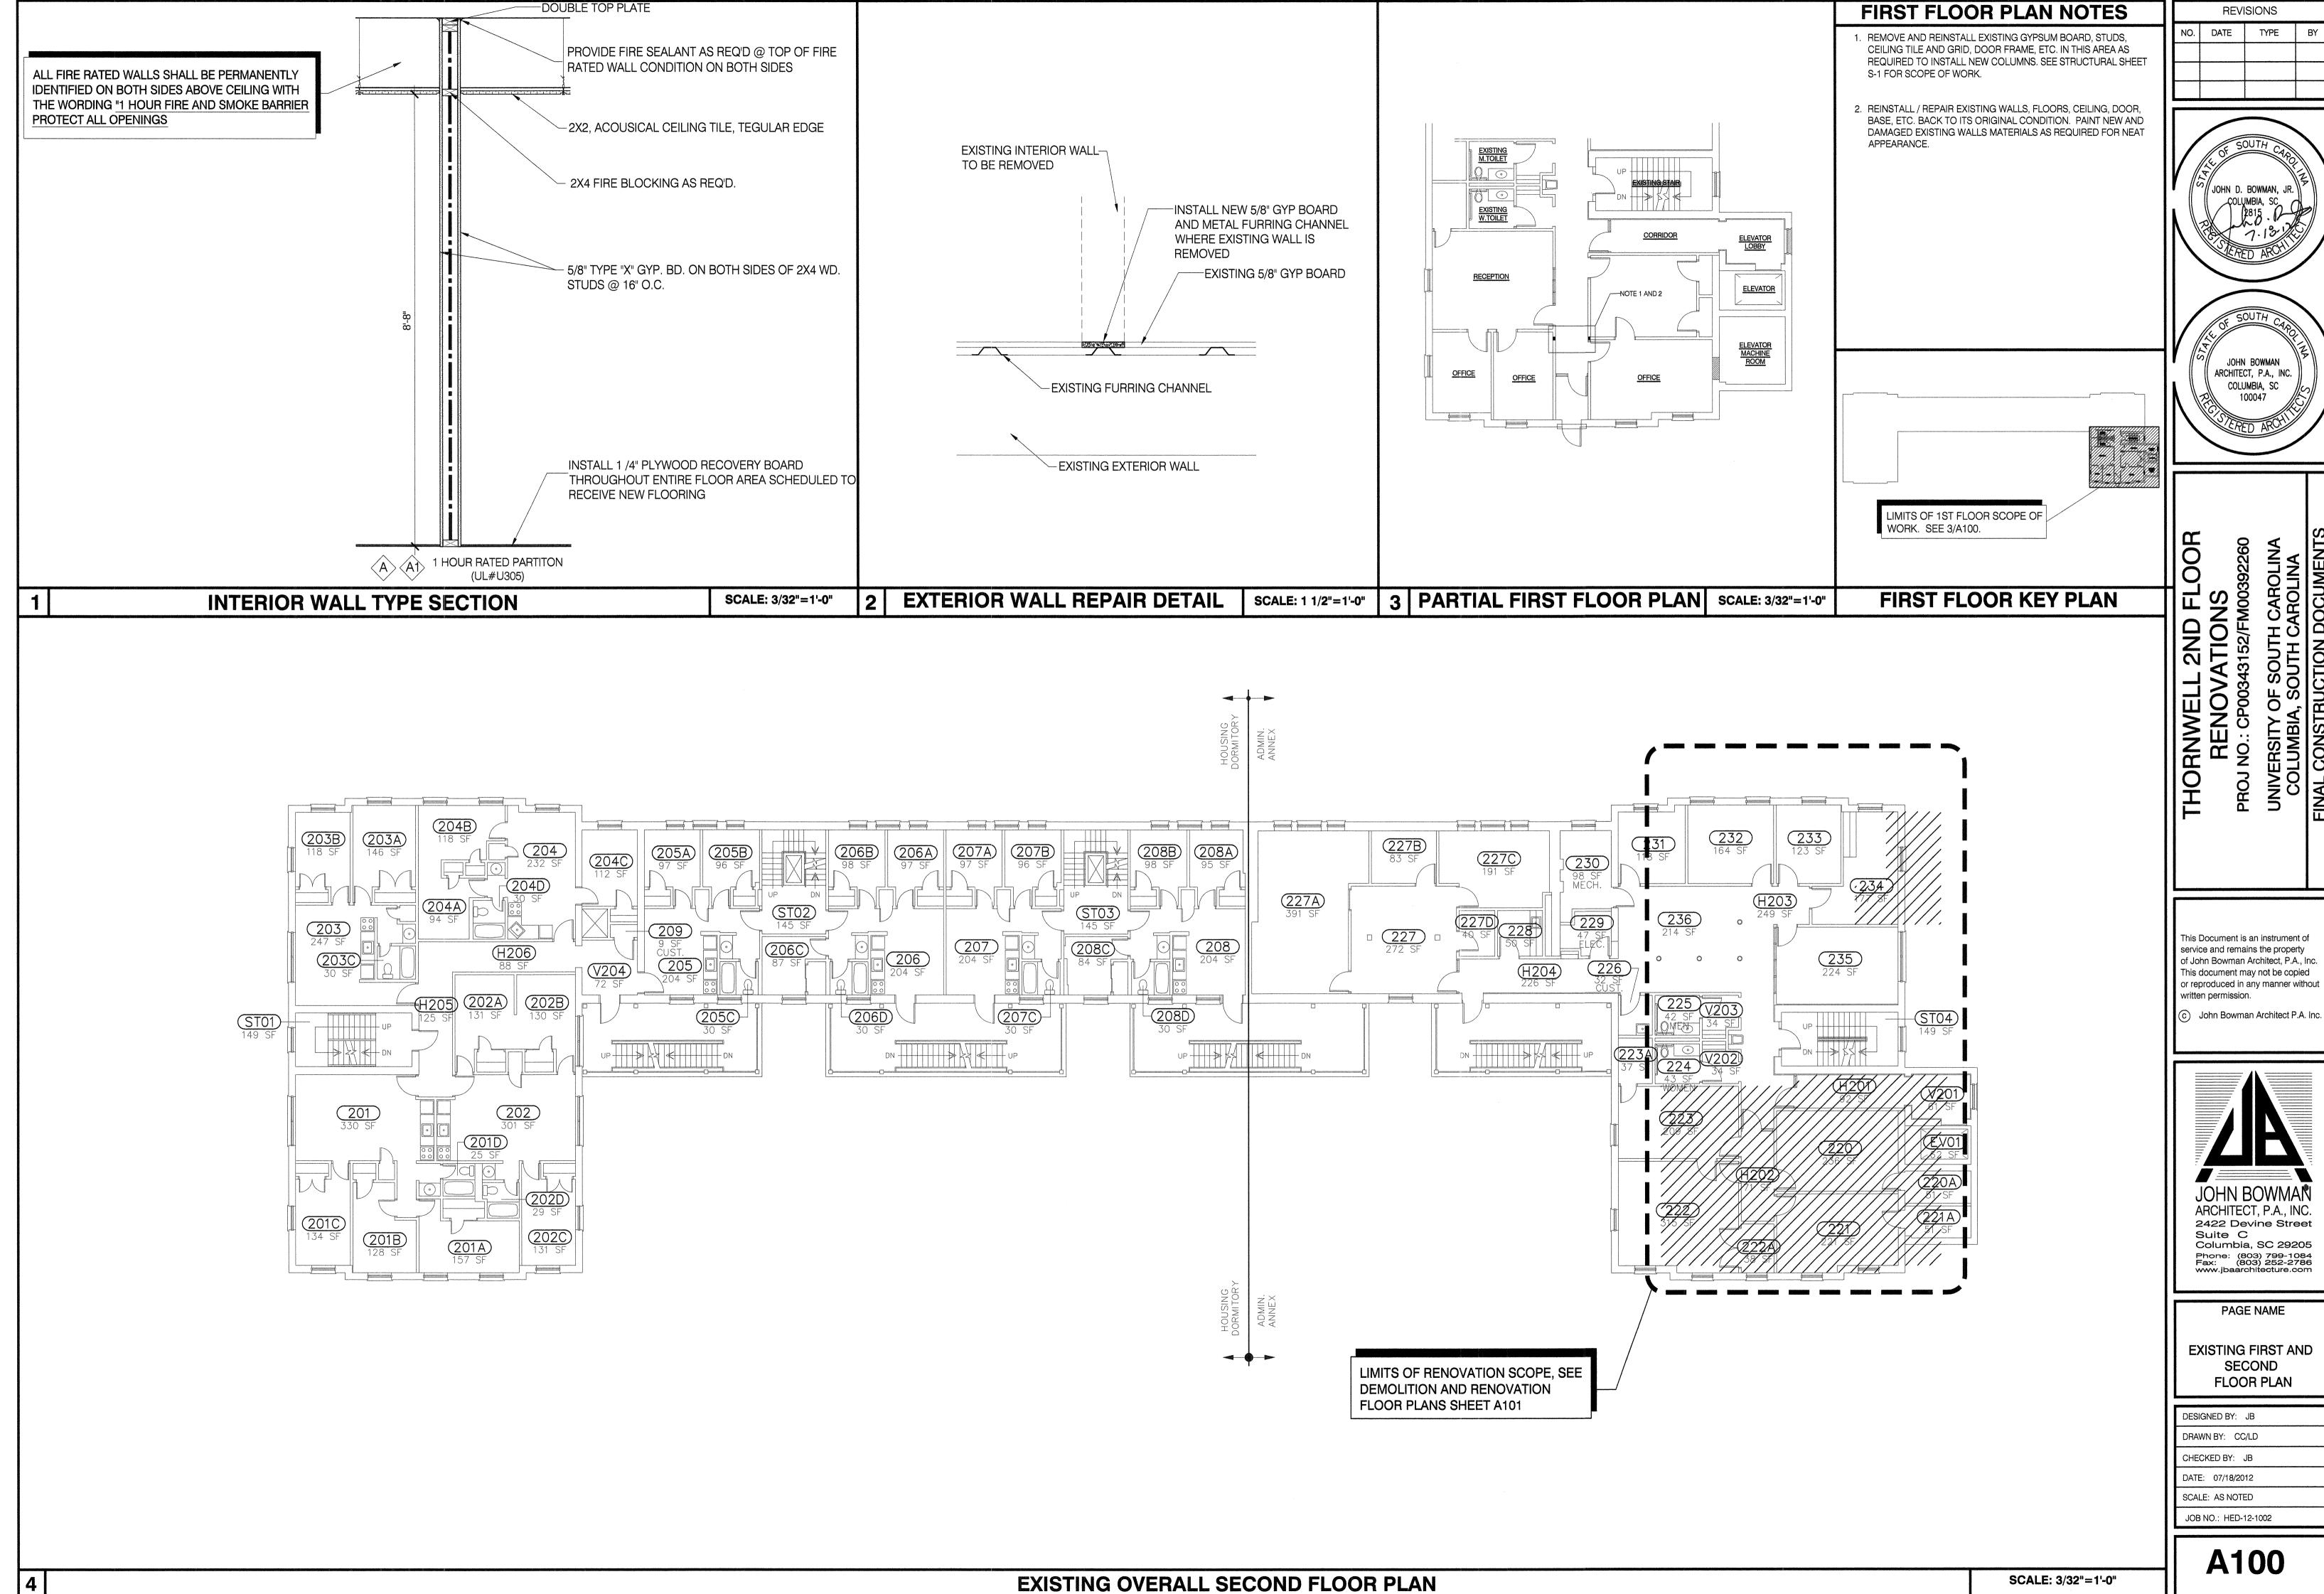


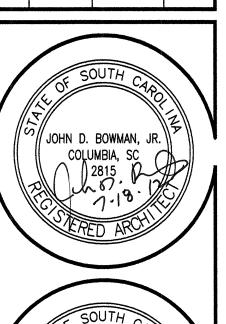
PAGE NAME LIFE SAFETY PLAN


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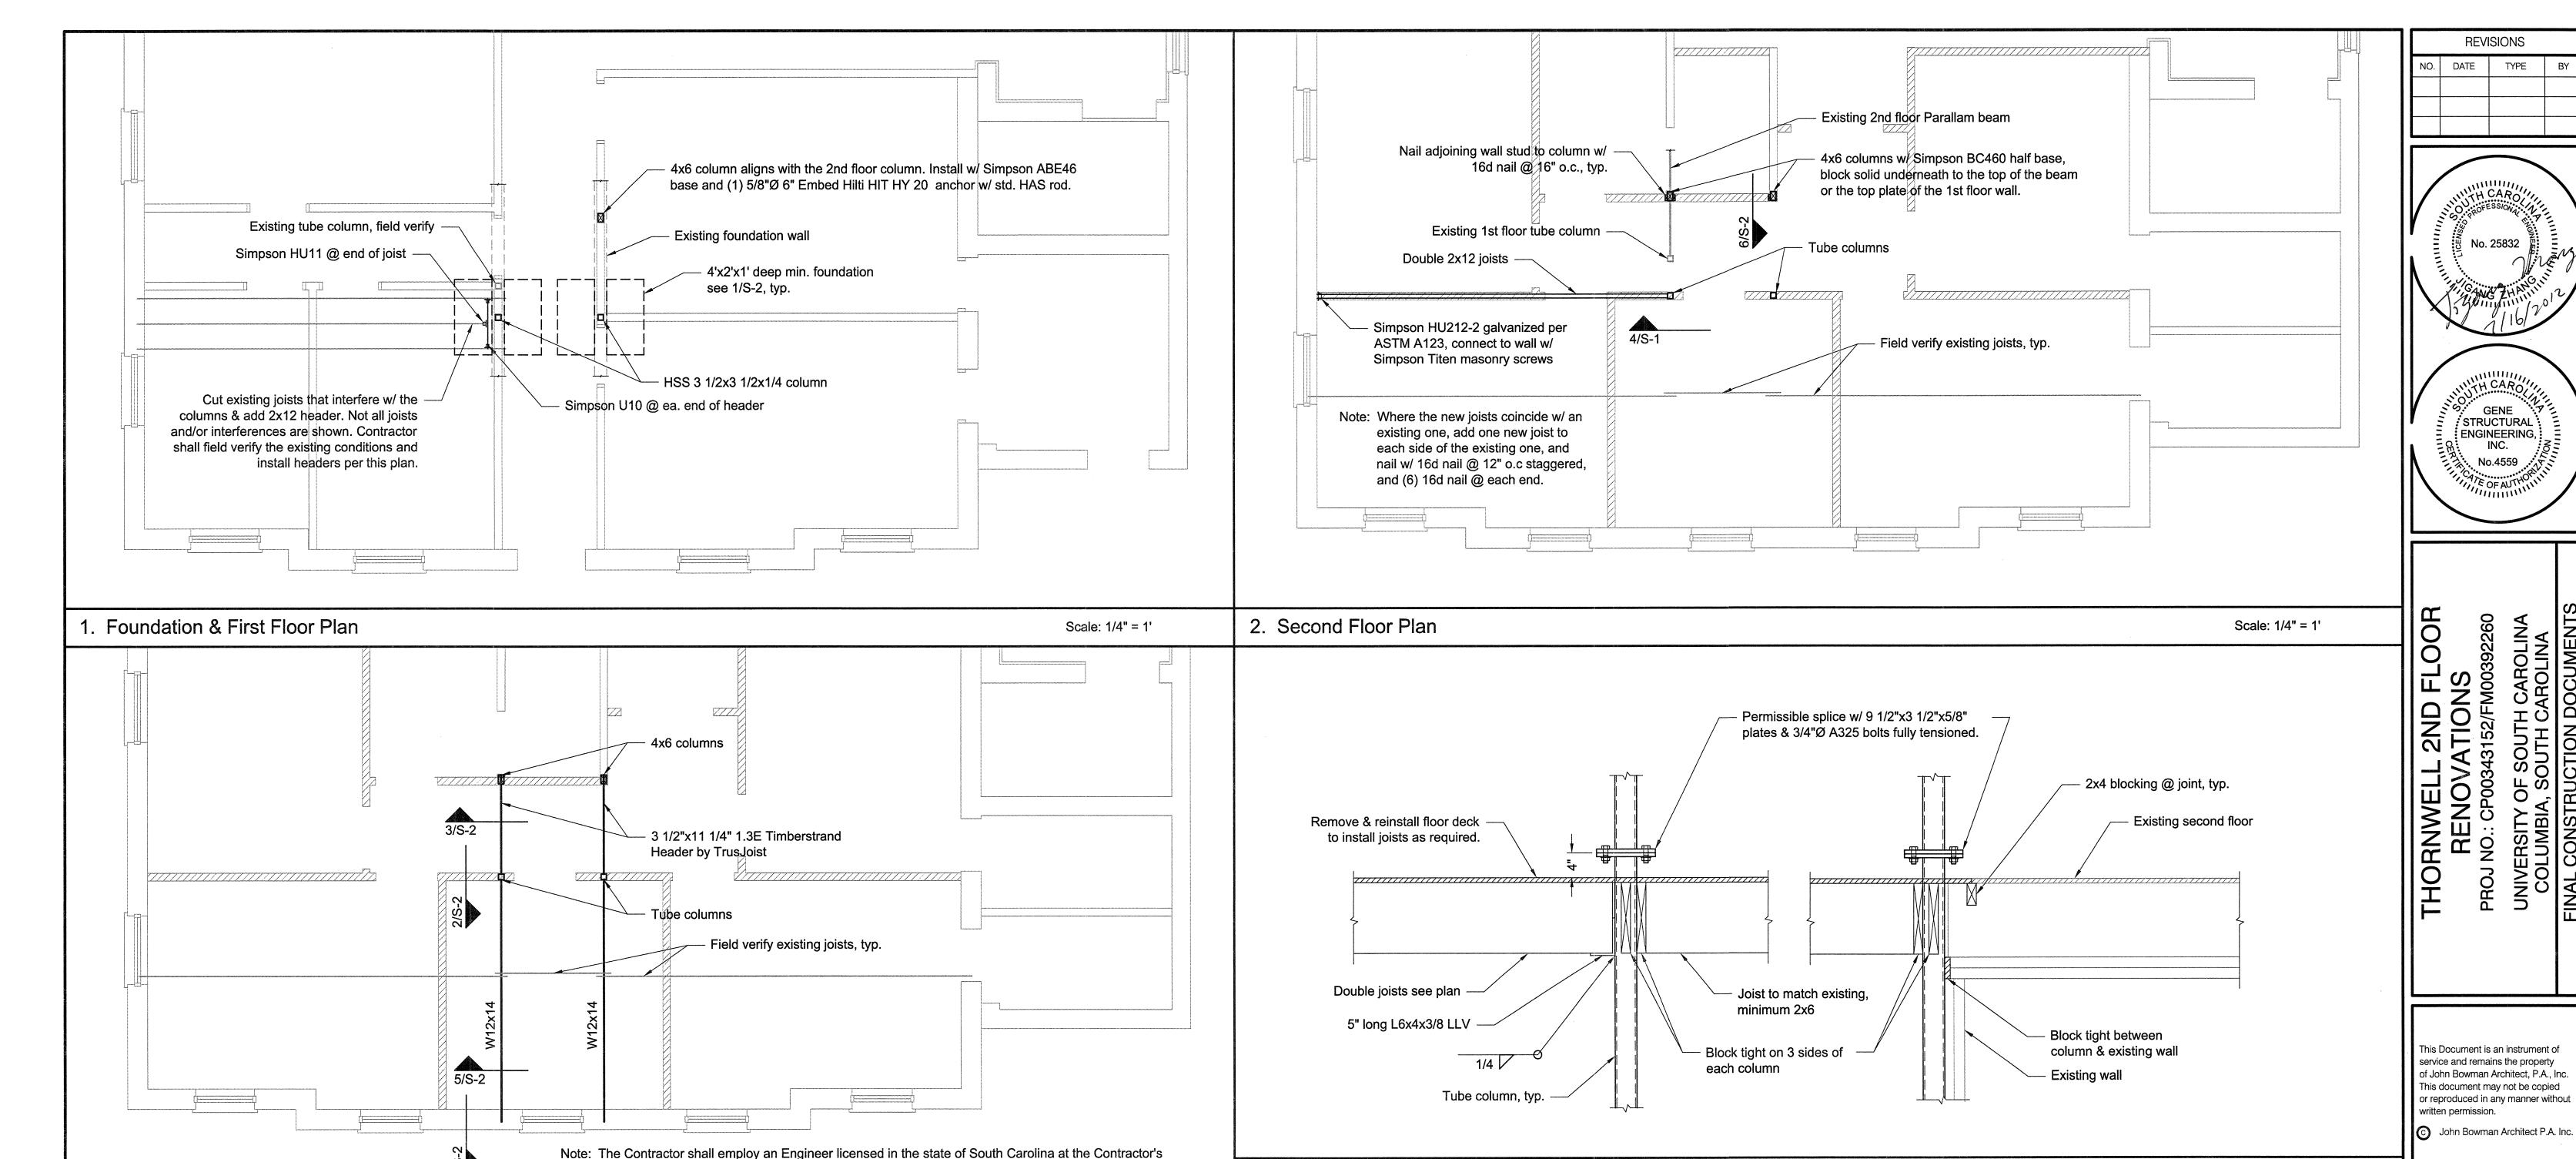
AND MISC DETAILS DESIGNED BY: JB DRAWN BY: CC/LD CHECKED BY: JB

DATE: 07/18/2012 SCALE: AS NOTED JOB NO.: HED-12-1002





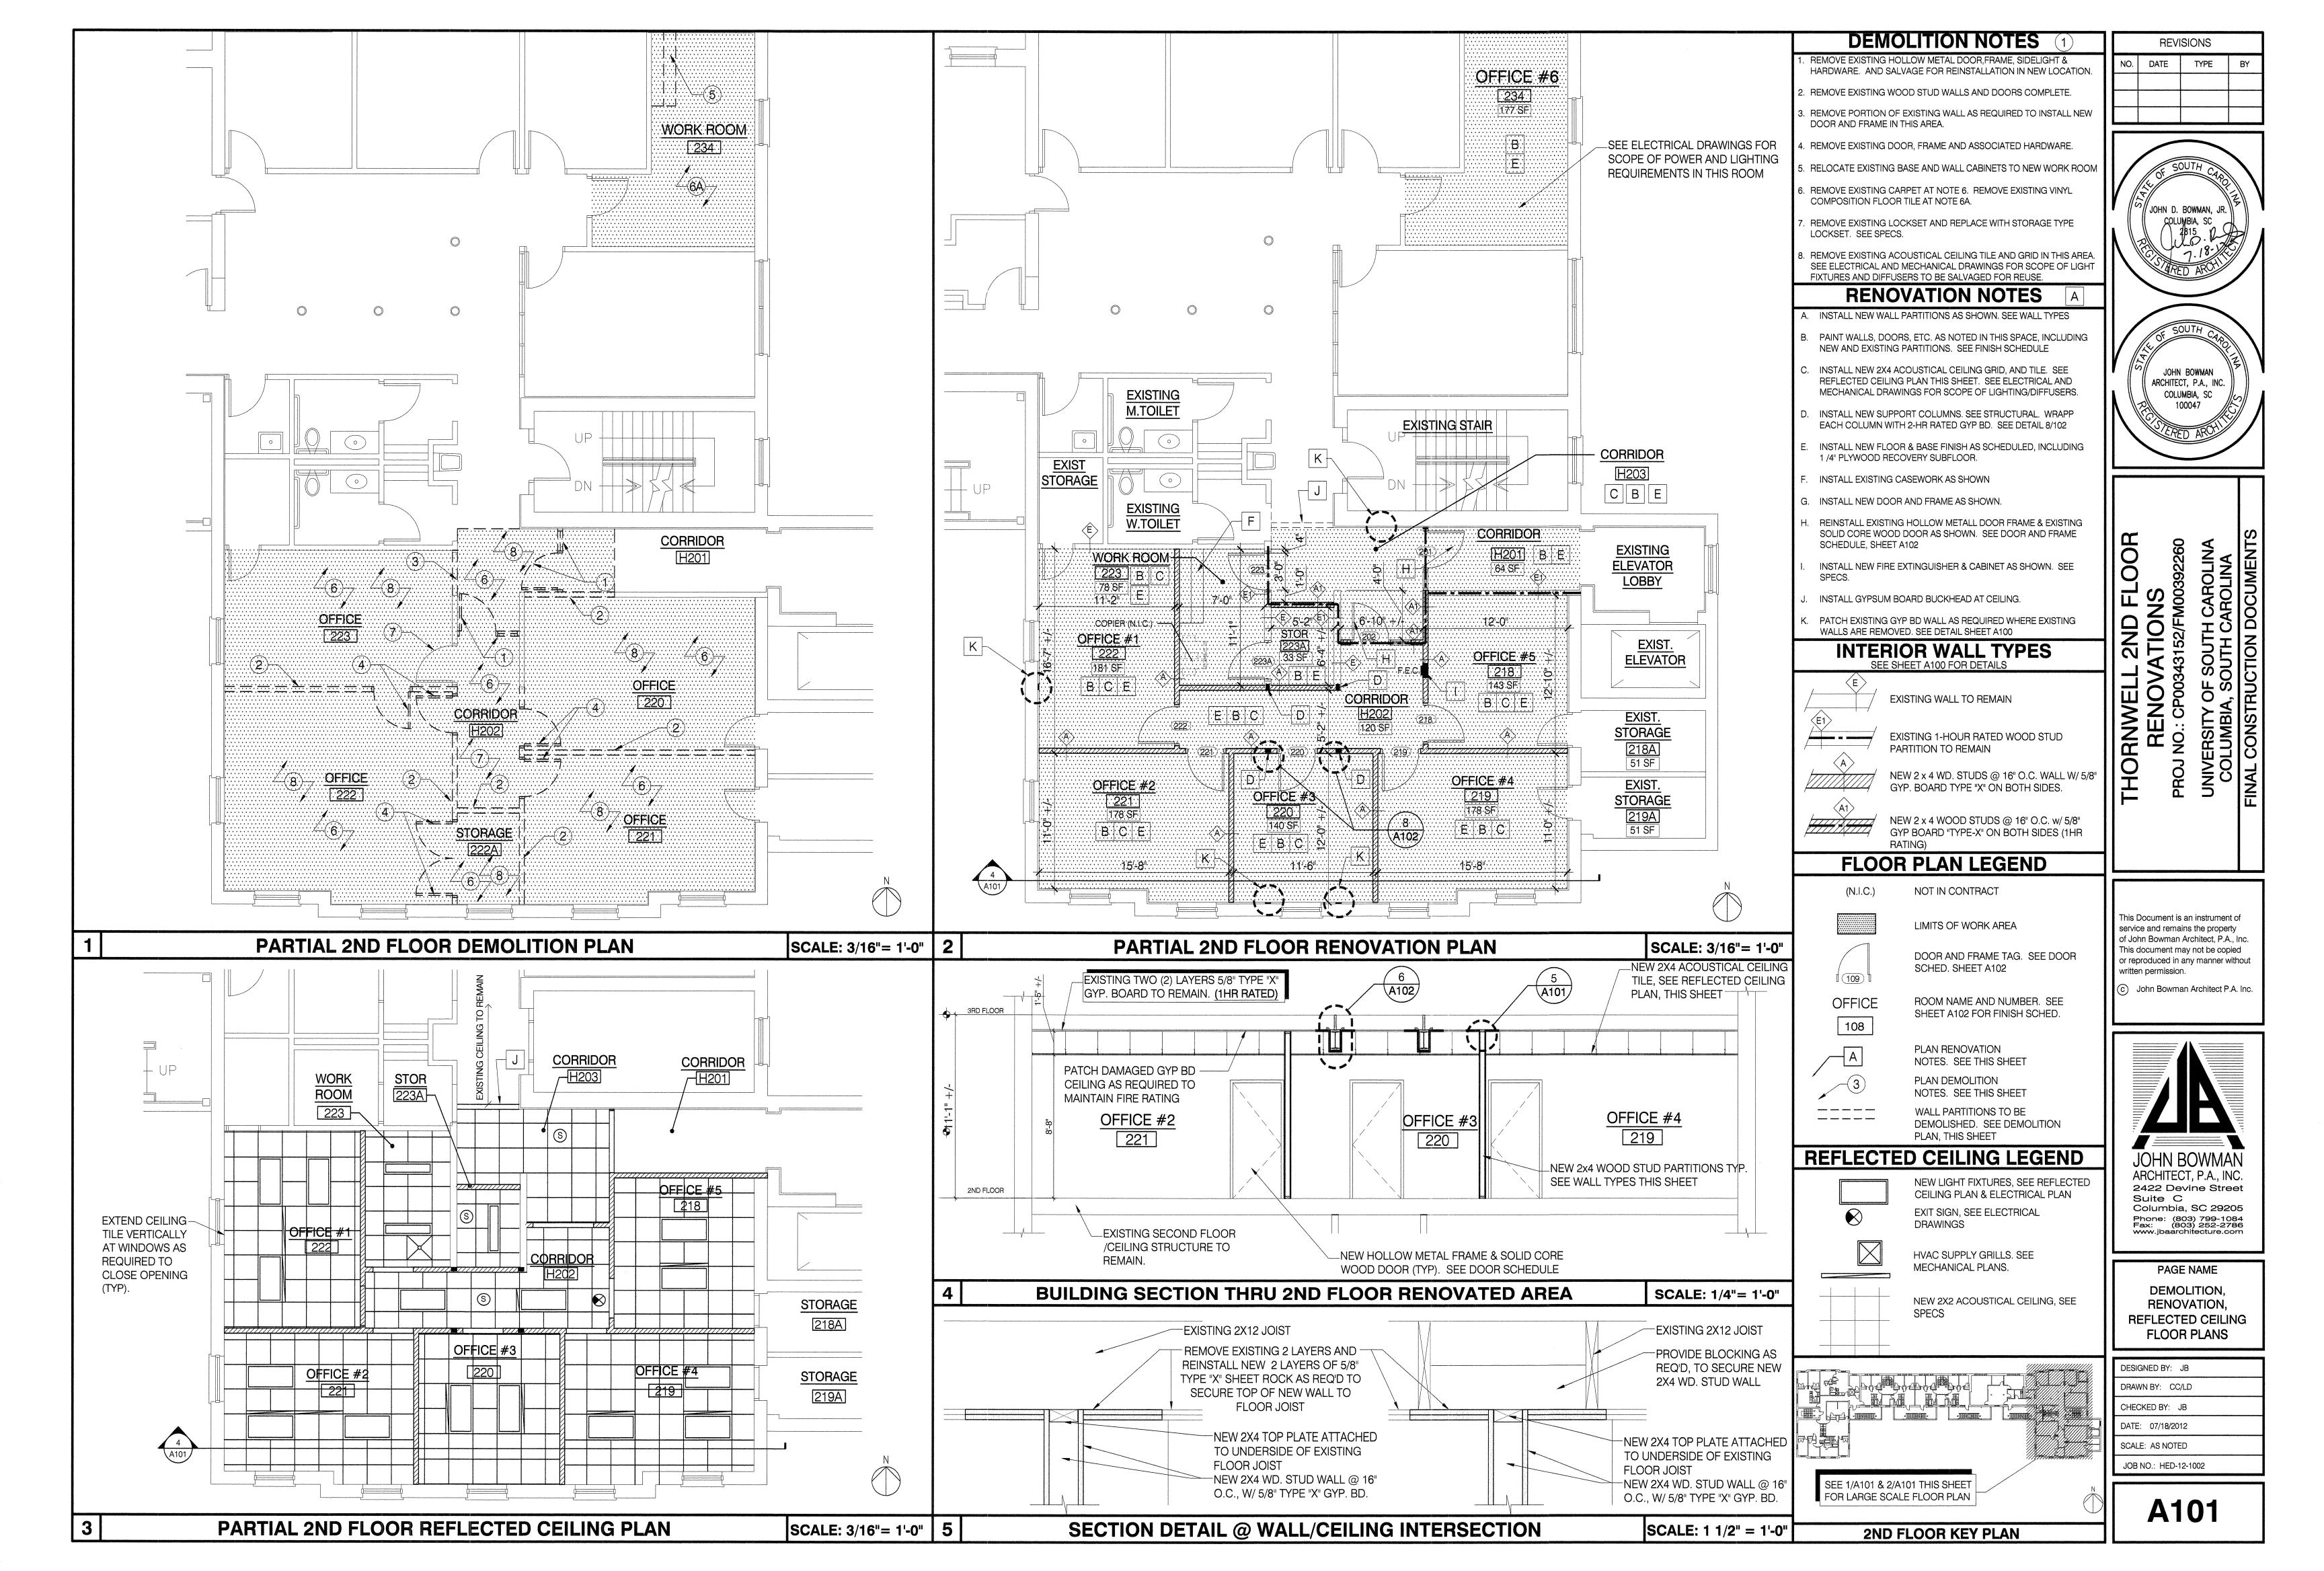

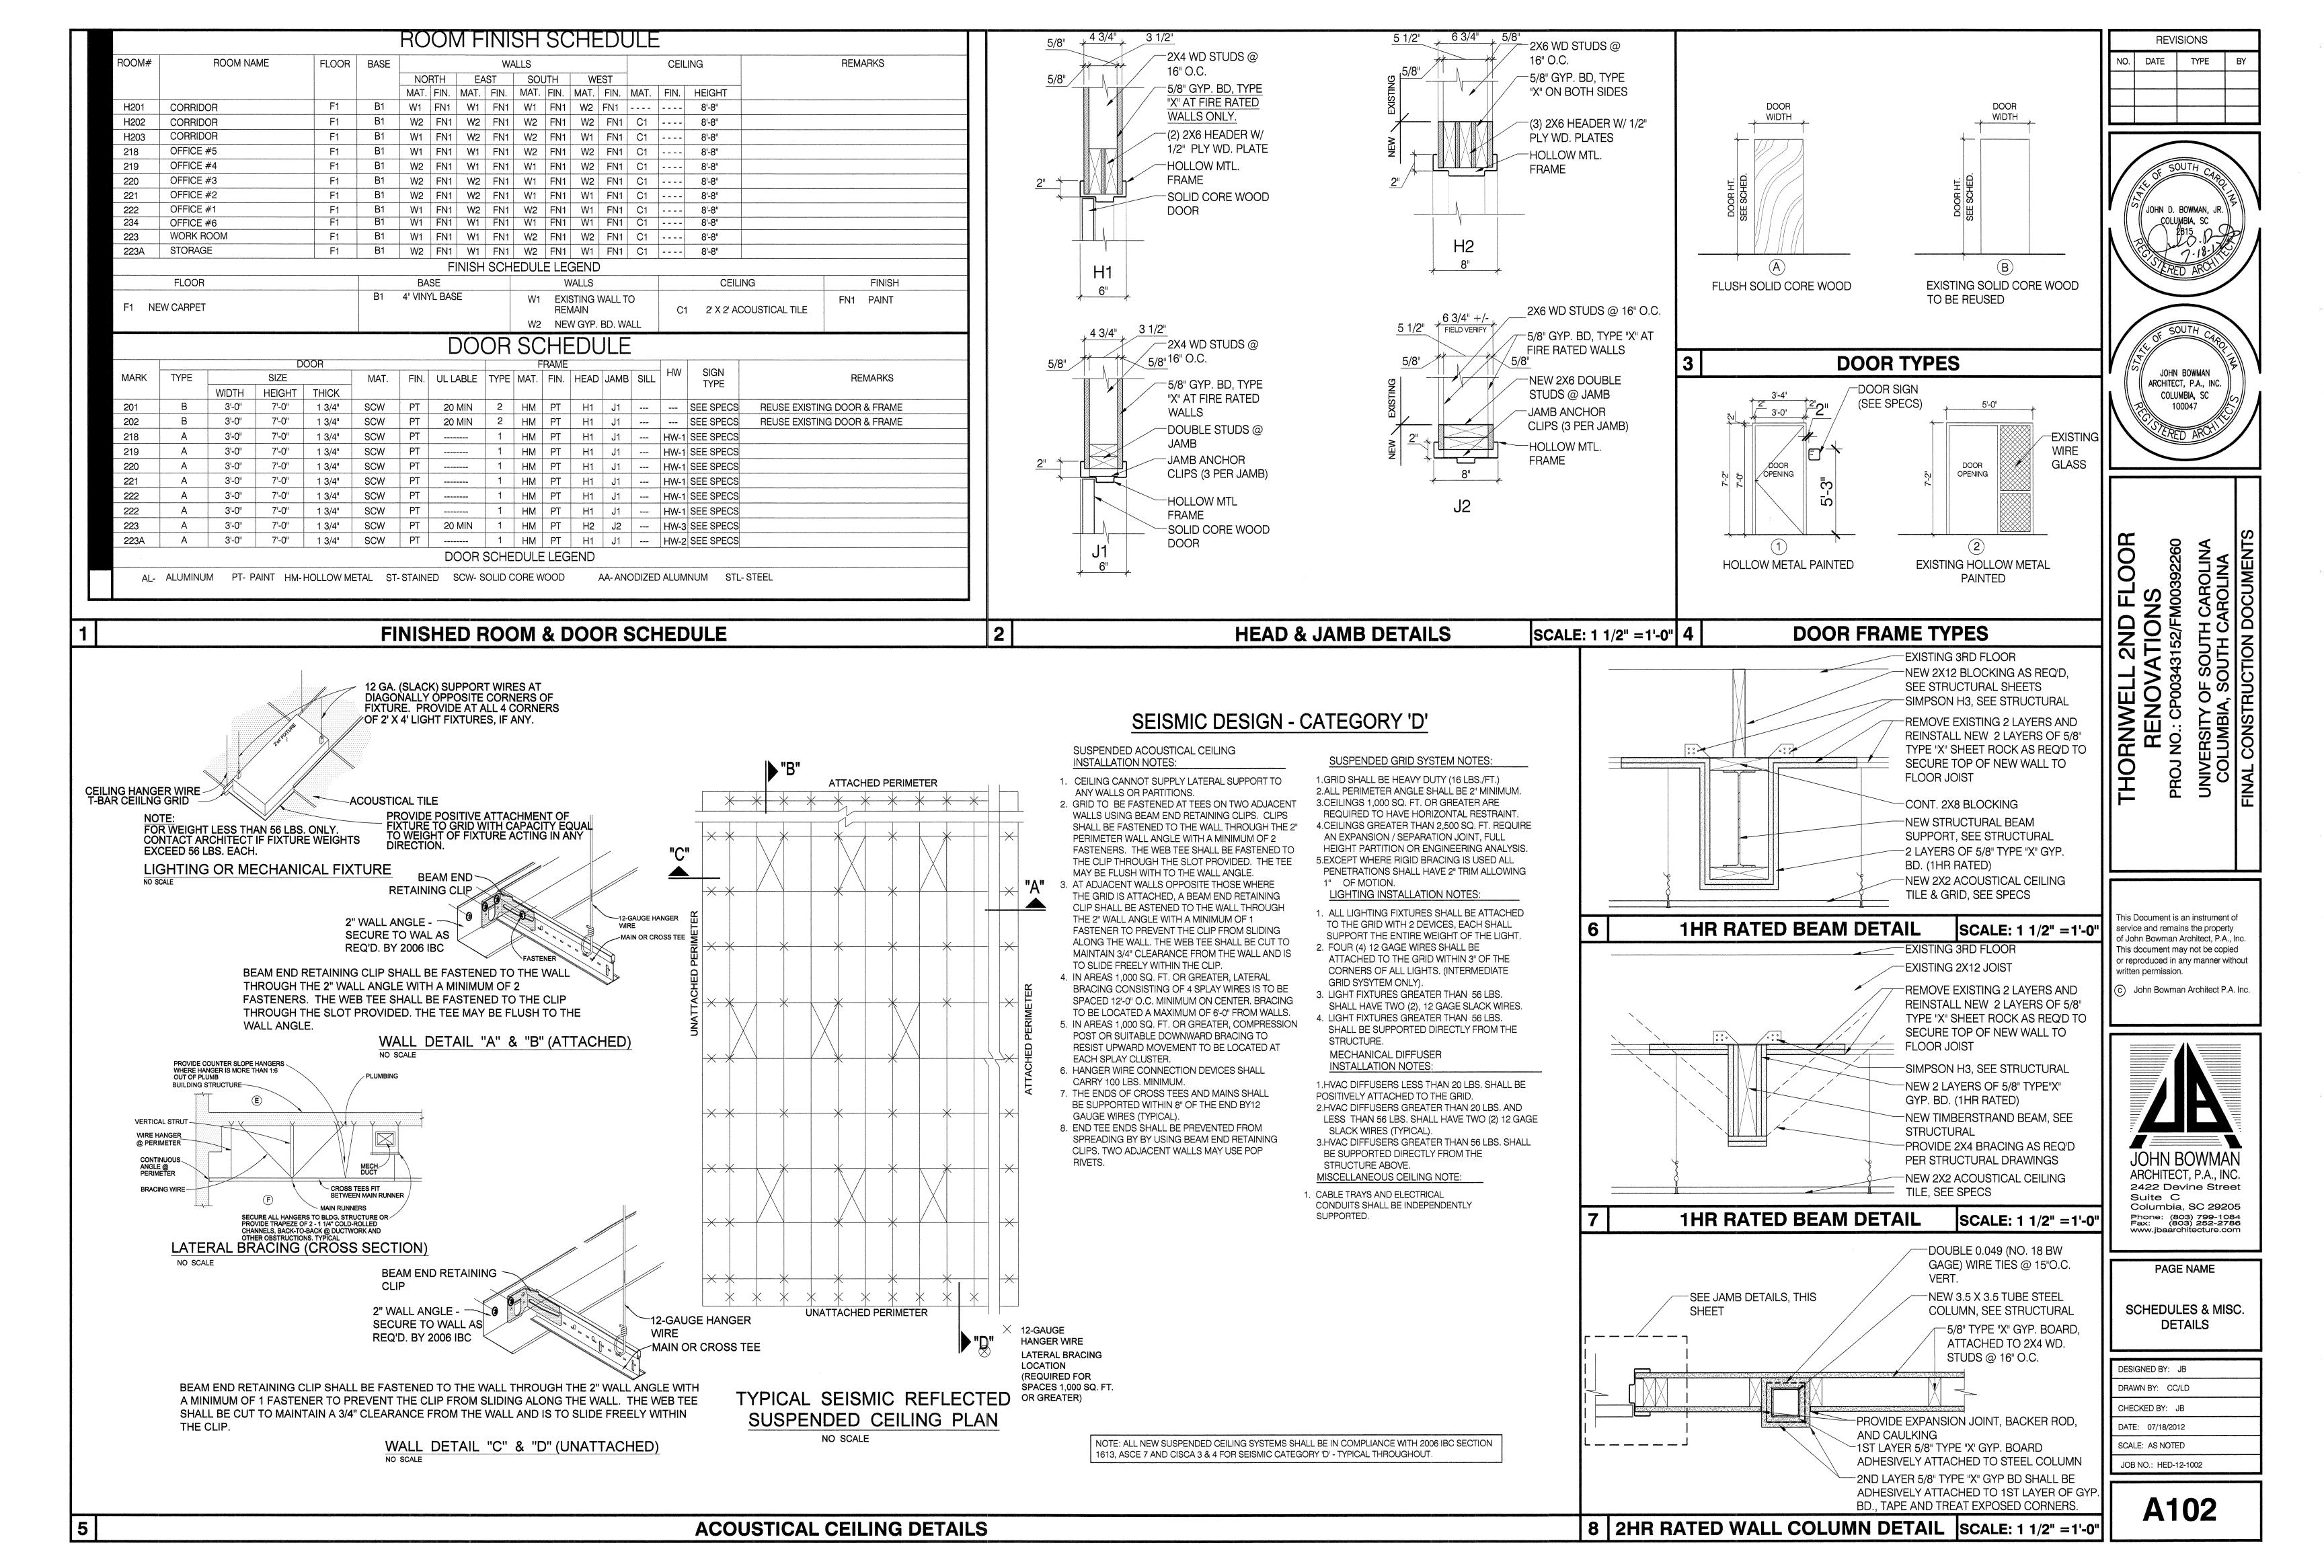

4. Second Floor Section

Wood:

- 1. The wood work shall comply with the AF&PA NDS-2005 "National Design Specification for Wood Construction".
- 2. All dimension lumber shall be Southern Pine No. 2 bearing the grade mark of a certified inspection agency. All lumber shall be Preservative Treated (PT) where and only where noted as such on plan. 3. All metal connectors shall be hot-dipped galvanized per ASTM A123 or ASTM
- A653. The minimum zinc coating shall be G185 1.85 oz. of zinc per square foot of surface area total both sides.
- 4. All fasteners including but not limited to nails, screws and bolts shall be hot-dipped galvanized per ASTM A153.
- The metal connectors shall be Simpson StrongTie as specified on the plans. Substitutes are subject to the Engineer's approval, and allowed only if the request is submitted with product data in advance. The product data must contain the connection capacity and product finish information and any other pertinent information.
- 6. Metal connectors installation shall comply strictly with the manufacturer's specification.
- All nails shall be commercial grade common wire nails. Nails shall be sufficiently spaced to develop maximum connection strength without splitting the members. All split members shall be replaced
- 8. All bolts used in wood connections shall be ASTM A307. Unless noted otherwise on plans, all bolts shall be installed with standard galvanized washers under both the heads and nuts. The bolts shall be torqued until the wood just begins to yield. The bolts shall not be overtorqued to deform the wood. Bolt holes shall be a minimum of 1/32" to a maximum of 1/16" larger than the bolt size. Where the bolt head is undersunk into wood, the wood member shall be cut so that the bolt head flushes with the member surface.
- All new floor deck thickness shall match the existing. The new floor deck shall have a minimum span rating of 48/24. Blocking with 2x6 shall be installed along all unsupported panel edges. The floor deck shall be nailed to the joists or blocking w/ 10d nails @ 6" o.c. along all panel edges and 12" o.c. along intermediate supports.

Structural Steel:

- 1. All structural steel work shall comply with AISC-360-05 "Specification for Structural Steel Buildings" and AISC 303-05 "Code of Standard Practice for Steel Buildings and Bridges".
- 2. All tube steel shall conform to ASTM A500 grade B, FY = 46,000 PSI. All W-section steel shall conform to ASTM A992, FY=50,000 PSI. All other structural steel shall conform to ASTM A36, FY = 36,000 PSI.
- 3. All welding shall comply with AWS D1.1 "Structural Welding Code Steel". All electrodes shall be E70XX grade. Unless noted otherwise on plans, all welds shall have a minimum thickness of 3/16".
- 4. Unless noted otherwise on plans, all bolts shall be A325-X and installed snug tight. All the connections using A325 or A490 bolts shall comply with RCSC "Specification for Structural Joints Using ASTM A325 or A490 Bolts".
- 5. All the structural steel shall have one coat of anti-rust paint and one coat of finish paint. The finish paint color shall be determined by the Owner. Prior to painting, all steel surfaces shall be prepared in accordance with Steel Structure Painting Council's "Surface Preparation Specification No. 3"(SSPC-SP 3).
- All paints are subject to the approval by the Owner prior to their use. 6. No openings in any structural members other than what is specified on the plans are
- allowed unless approved in writing by the Engineer. No gas-cutting of structural steel is allowed.
- 8. No field modification of any structural steel members is allowed unless approved in writing by the Engineer.
- The Contractor shall employ an independent inspection agency to inspect the structural steel work and verify that it complies with the requirements of the contract documents.
- 10. Unless noted otherwise on plans, all columns shall have 5/8" thick cap plates.

Anchor Bolts:

- 1. Anchor bolts shall be as specified on the plan. Substitutes are subject to the Engineer's approval, and allowed only if
- the request is submitted with product data in advance. 2. All anchor bolts shall be installed strictly according to the manufacturer's recommendations.



Scale: 1" = 1'

JOHN BOWMAN ARCHITECT, P.A., INC. 2422 Devine Street Suite C Columbia, SC 29205 Phone: (803) 799-1084 Fax: (803) 252-2786 www.jbaarchitecture.com

PAGE NAME

Plans & Notes

DRAWN BY: GZ CHECKED BY: GZ DATE: 07/18/2012 SCALE: AS NOTED JOB NO.: 120001

DESIGNED BY: GZ

S-⁻

3. Second Floor Ceiling Framing Plan (Third Floor Framing)

General Notes:

Design Specifications: International Building Code (2006 Edition).

2. Design Loads: Roof live load: 20 PSF Snow load: 10 PSF Floor live load: Office: 50 PSF First Floor Corridor: 100 PSF

Upper Floor Corridor: 80 PSF

Dead load: Actual Where there is a discrepancy in dimensions and/or details between Architectural and Structural drawings, the Architectural drawings shall govern, provided that the strength is not

- Where a detail is shown on Structural drawings for one condition, it shall apply to all like conditions, unless noted or shown otherwise on plans.
- The Contractor is responsible for the construction falsework design if any is needed. The design shall be performed, sealed and signed by an Engineer licensed in the state of South Carolina and shall be submitted for approval before commencing of the work.
- on the drawings. Unless the Contractor obtains a written approval from the Engineer, no field alteration of any element is allowed that will cause violation of the drawings and/or the specifications in any

6. All elements shall be securely installed square, plumb, and true, or in other positions as shown

- parts or works. During the shop drawing process, the Contractor shall clearly cloud line all the deviations from the original design, and shall obtain written approval from the Engineer prior to fabrication.
- The dimensions shown with a suffix "±" are approximate. The Contractor shall be responsible

to measure the accurate dimensions prior to fabrication.

General Notes (cont'd):

See Architectual drawing for the demolition plans.

10. If the Contractor finds a difference between these drawings and the existing conditions, or finds any other conditions that prohibit execution of the work as specified in these drawings, the Contractor

Scale: 1/4" = 1'

- shall notify the Engineer immediately and await for further directions on the affected works. 11. The Contractor shall employ at the Contractor's expense an independent agency to perform the quality assurance, sampling, testing and/or inspection. The selection of the agency is subject to the Engineer's approval.
- 12. The foundation design is based on an allowable soil bearing pressure of 1500 PSF. The Contractor shall employ at the Contractor's expense a Geotechnical Engineer licensed in the state of South Carolina to verify the foundation excavation before the placement of foundation
- 13. The Contractor shall be solely responsible for all the costs associated with correcting any unapproved field alterations, unapproved fabrication deviations, items that the Contractor is responsible for, and/or the Contractor's failure to follow the contract documents and these directions.

Concrete:

1. The concrete's minimum compressive strength shall be 3,000 PSI at 28 days.


2. All the rebar shall be A615 grade 60 steel.

expense to design the temporary shoring and bracing and submit the design for the Engineer of

Record's review. The temporary shoring and bracing shall be installed prior to the demolition of the second floor load bearing walls, and the temporary shoring and bracing shall not be removed until

all the columns and beams are completely installed to their final positions and braced to the floors.

- 3. Concrete work shall comply with ACI 301-05 "Specifications for Structural Concrete" and the applicable provisions of ACI 318-05 "Building Code Requirements for Structural Concrete".
- 4. The detailing, fabricating, and placing of reinforcing steel and accessories shall comply with ACI 315-99 "Details and Detailing of Concrete Reinforcement", ACI 318-05 and ACI 301-05, and shall conform with CRSI Manual of Standard Practice current edition.
- 5. The Contractor shall employ a testing laboratory at the Contractor's expense to perform concrete strength testing per ACI 318-05. The selection of the testing laboratory is subject to the Engineer's approval.

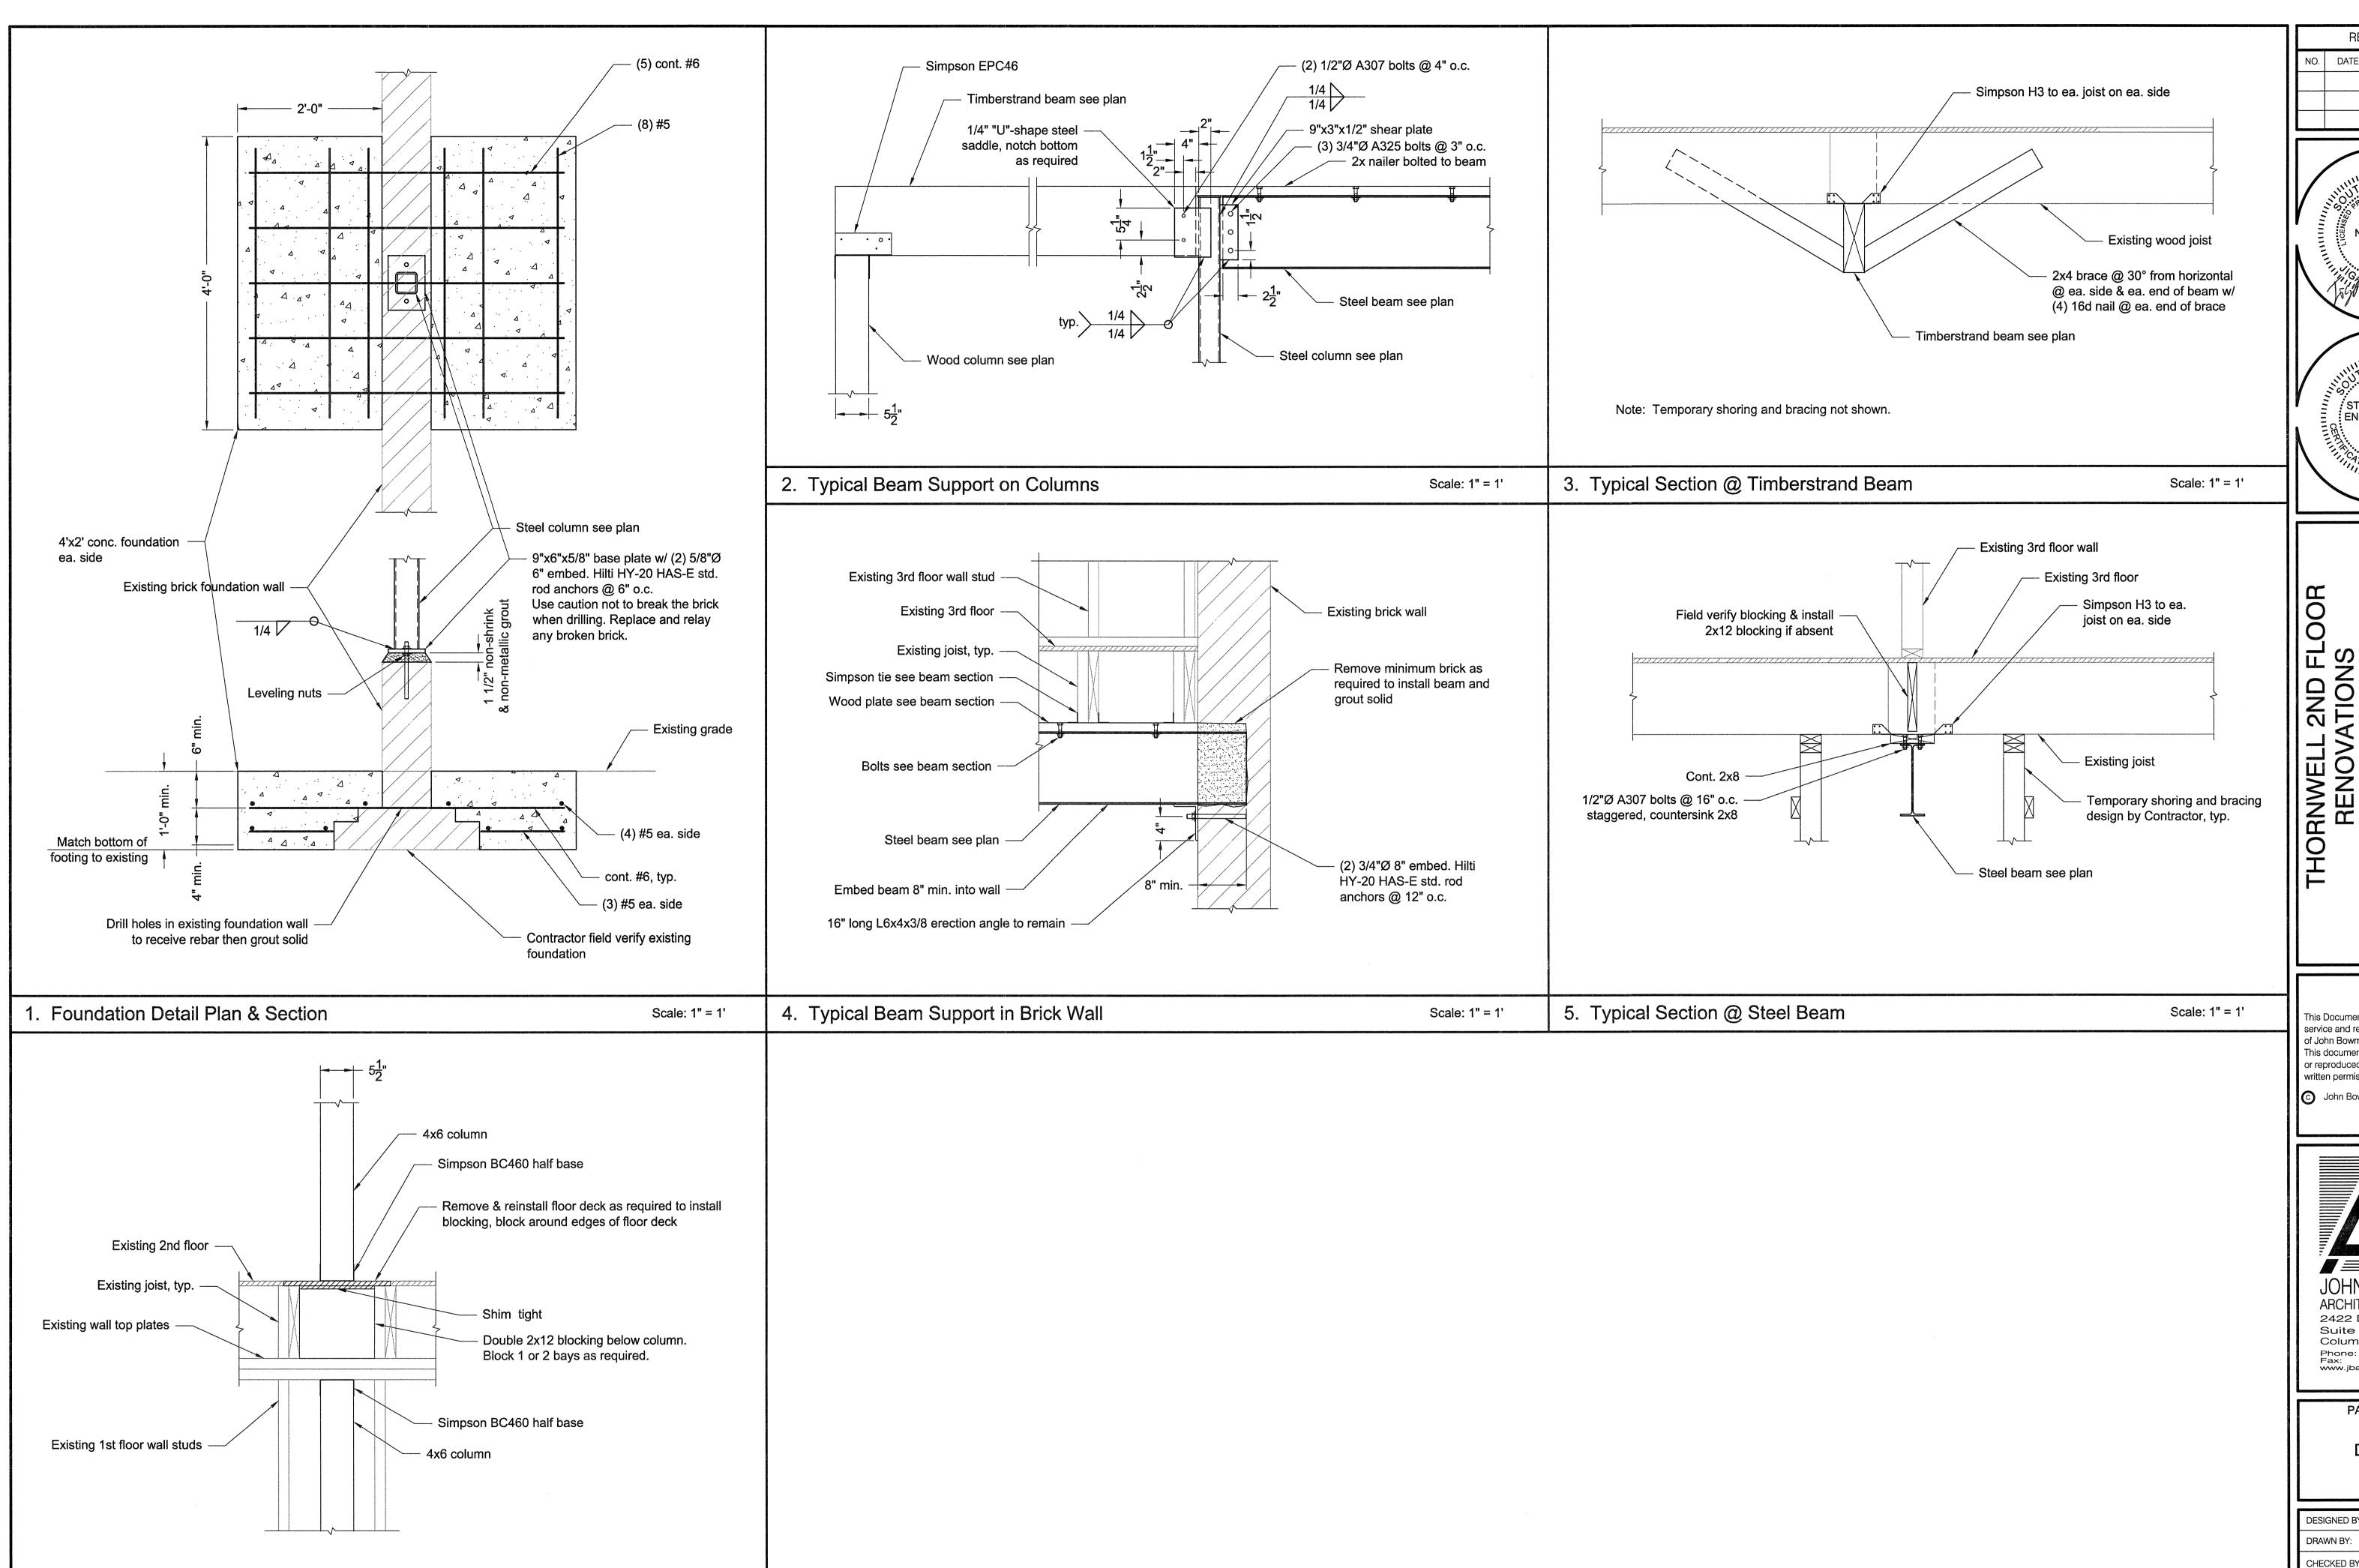


Note: block similarly where the 2nd floor joists are on top of Parallam beam.


Scale: 1" = 1'

6. Wood Column Support @ Second Floor

REVISIONS

O. DATE TYPE BY

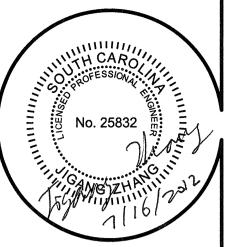

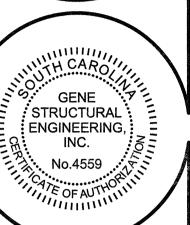

HOKNWELL 2ND FLOOK
RENOVATIONS
PROJ NO.: CP00343152/FM00392260
UNIVERSITY OF SOUTH CAROLINA

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PAGE NAME

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CHECKED BY: GZ


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DATE: 07/18/2012

SCALE: AS NOTED

JOB NO.: 120001


S-2

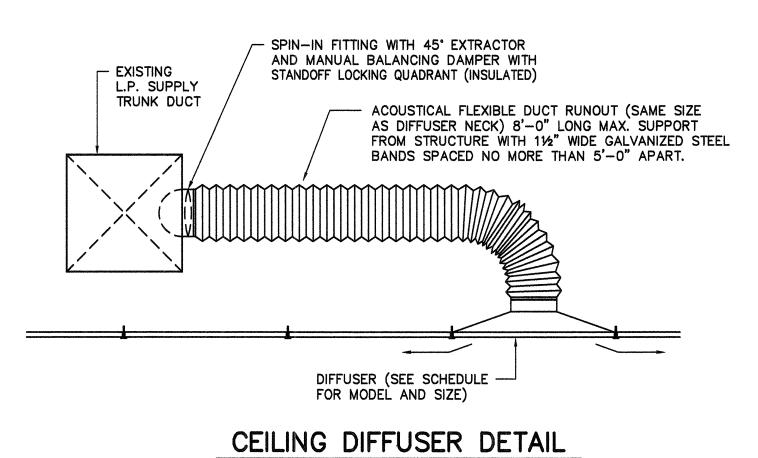

NO SCALE

		 	ON			
F	Shall be a second	1.0	ea . at a.d	12.0	12 11 14 15 15	1 1 2

- 1) DIFFUSER TO BE RELOCATED. SEE 2/M-1.
- 2 REMOVE RUNOUT DUCT AND CAP TAKEOFF AT MAIN TRUNK. PATCH INSULATION TO
- 3 REMOVE FLEXIBLE DUCT RUNOUT.
- 4 WALL THERMOSTAT TO BE RELOCATED. SEE 2/M-1.

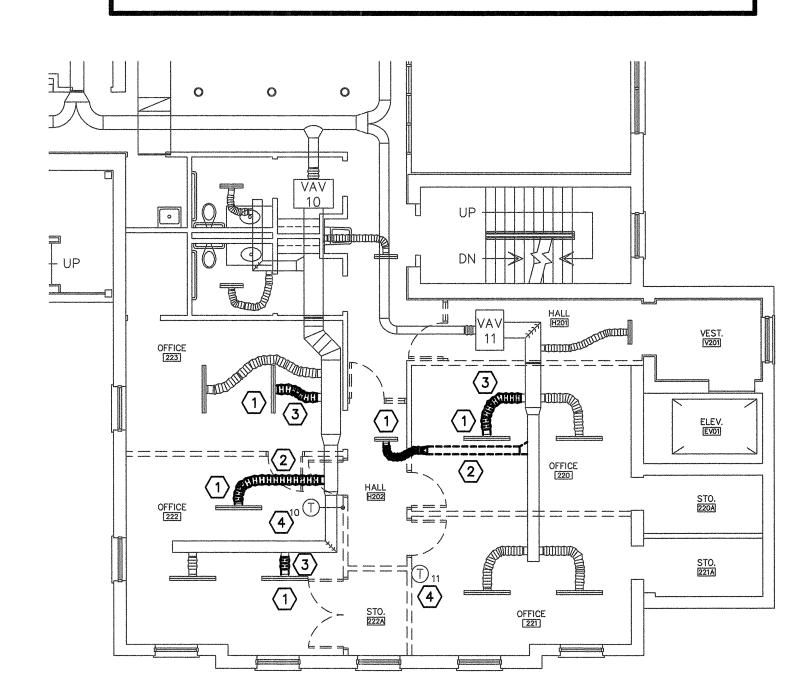

	1	DEMOLITION FLOOR PLAN	
N	M-1	SCALE: 1/8" = 1'-0"	

AIR DISTRIBUTION SCHEDULE MODEL FRAME CFM NECK SIZE FACE SIZE MAX NC REMARKS DESCRIPTION MANUFACTURER APDC LAY-IN 126-225 24"x24" PERFORATED SUPPLY 8"ø 1,2,3 PRICE 30

. PROVIDE WITH STANDARD WHITE FINISH.

RETURN AIR TRANSFER
OPENING ABOVE CEILING
(TYPICAL PER SIZE SHOWN)
26x10

RENOVATION FLOOR PLAN

- 2. PROVIDE ALUMINUM CONSTRUCTION.
- 3. PROVIDE WITH INDIVIDUALLY ADJUSTABLE CURVED BLADES.


CONTRACTOR	AND SHALL BE DISPOSED OF PI
OPERATIONS II	STEMS SHALL NOT BE OPERATE NCLUDING MASONRY, GYPSUM B OTHER ACTIVITIES THAT CREA
	LEGENI
SYMBOL	
	A A


GENERAL NOTES

- VISIT SITE PRIOR TO BIDDING. THIS CONTRACTOR SHALL DETERMINE DIFFICULTY OF INSTALLATION AND REFLECT THIS IN HIS BIDDING.
- 2. DO NOT SCALE DRAWINGS. SEE ARCHITECTURAL DRAWINGS AND REFLECTED CEILING PLANS FOR EXACT LOCATIONS OF DOORS, WINDOWS, AIR DISTRIBUTION, ETC. THIS CONTRACTOR SHALL VERIFY ALL EXISTING ITEMS AND LOCATIONS IN THE FIELD.
- 3. SPACE ABOVE CEILING TO BE USED AS RETURN AIR PLENUM. RETURN AIR ENTERS PLENUM THROUGH RETURN AIR LIGHT FIXTURES.
- 4. THIS CONTRACTOR SHALL BE RESPONSIBLE FOR ALL CONTROL WIRING. CONTROL WIRING SHALL BE CONCEALED WITHIN WALL. ALL MODIFICATIONS TO THE CONTROL SYSTEM SHALL BE PERFORMED BY JOHNSON CONTROLS, INC. CONTACT GILL HOLLAND AT (803) 749-7336.
- 5. LOCATE ALL SPACE CONTROL INSTRUMENTS 4'-0" ABOVE FINISHED FLOOR TO OPERABLE PORTION OF DEVICE.
- 6. ITEMS REMOVED UNDER THIS CONTRACT SHALL BECOME THE PROPERTY OF THE CONTRACTOR AND SHALL BE DISPOSED OF PROPERLY.
- TED DURING HEAVY CONSTRUCTION
 BOARD SANDING, HEAVY CLEANUP
 EATE AIRBORNE PARTICLES OR DEBRIS.

	LEGEND	
SYMBOL	DESCRIPTION	
(A) 100	TYPE "A" DIFFUSER, 100 CFM	
E 100	EXISTING DIFFUSER, 100 CFM	
® 100	RELOCATED DIFFUSER, 100 CFM	
Û	THERMOSTAT	
•	CONNECTION POINT OF NEW TO EXISTING	

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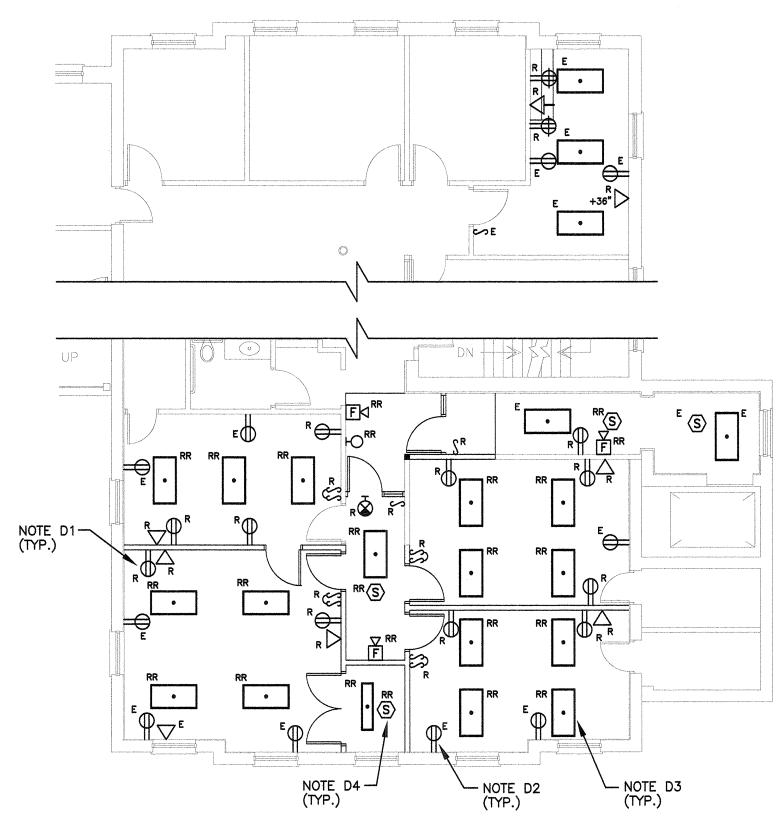
Suite C Columbia, SC 29205 Phone: (803) 799-1084 Fax: (803) 252-2786 architectj@bellsouth.net

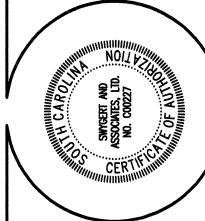PAGE NAME FLOOR PLANS, DETAIL, NOTES, SCHEDULE, AND LEGEND

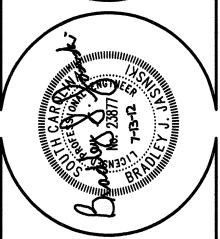DESIGNED BY: BJJ
DRAWN BY: BJJ
CHECKED BY: BJJ
DATE: 07/18/2012
SCALE: AS NOTED
JOB NO.: 12260

CONSULTING ENGINEERS DBA Swygert & Assoc., Ltd. Telephone: (803) 791-9300 Facsimile: (803) 791-0830 Columbia, S.C. 29211 Telephone: (803) 791-0830 mail@swygert-associates.com

Swygert & Associates




ELECTRICAL DEMOLITION PLAN SCALE: 1/8" = 1'-0"

ELECTRICAL DEMOLITION NOTES

- D1. ALL DEVICES AND FIXTURES DENOTED WITH "R" SHALL BE REMOVED BY THE ELECTRICAL CONTRACTOR DURING DEMOLITION.
- D2. ALL DEVICES AND FIXTURES DENOTED WITH "E" SHALL REMAIN IN PLACE. ANY DEVICE OR FIXTURE DAMAGED SHALL BE REPLACED BY ELECTRICAL CONTRACTOR.
- D3. ALL DEVICES AND FIXTURES DENOTED WITH "RR" SHALL BE REMOVED DURING DEMOLITION PHASE AND RE-INSTALLED DURING RENOVATION PHASE. PROTECT WHEN REMOVING AND STORING DURING DEMOLITION PHASE. ANY DEVICE OR FIXTURE DAMAGED SHALL BE REPLACED BY ELECTRICAL CONTRACTOR.
- D4. REMOVE EXISTING SMOKE DETECTORS FROM CEILING AND BAG DURING DEMOLITION. CLEAN AND RE-INSTALL DETECTORS IN NEW CEILING IN SLIGHTLY DIFFERENT LOCATIONS.

ELECTRICAL SYMBOL LEGEND LIGHTING FIXTURES (SEE LIGHTING FIXTURE SCHEDULE) LIGHTING FIXTURES WITH EMERGENCY BATTERY BACKUP POWER (SEE NOTE L3 EXIT SIGN, CEILING OR WALL MOUNTED (DIRECTIONAL ARROW INDICATES CHEVRON) SINGLE POLE SWITCH, MOUNTED 48" AFF (LETTER DENOTES SWITCHLEG) MULTI-LEVEL SWITCHING CONFIGURATION, MOUNTED 48" AFF (ONE SWITCH CONTROLS ALL INBOARD LAMPS; OTHER SWITCH CONTROLS ALL OUTBOARD LAMPS) 20 AMP DUPLEX RECEPTACLE, MOUNTED 18" AFF (NUMBER DENOTES CIRCUIT) 20 AMP DUPLEX RECEPTACLE, MOUNTED 42" AFF OR 6" ABOVE COUNTER BACKSPLASH VOICE/DATA STATION, WALL MOUNTED 18" AFF UNLESS NOTED OTHERWISE. PROVIDE 4" SQUARE BOX WITH SINGLE GANG PLASTER RING. PROVIDE 1" CONDUIT TO TELCOM ROOM. PROVIDE EDGE PROTECTION. SEE USC DOCUMENT "GENERAL GUIDELINES COMMUNICATIONS INFRASTRUCTURE UNIVERSITY OF SOUTH CAROLINA REVISED 5/12". PROVIDE CABLING, JACKS, CONNECTIONS, FACEPLATES, LABELING AND TESTING. VOICE/DATA STATION, WALL MOUNTED ABOVE COUNTER TOP UNLESS NOTED OTHERWISE. PROVIDE 4" SQUARE BOX WITH SINGLE GANG PLASTER RING. PROVIDE 1" CONDUIT TO TELCOM ROOM. PROVIDE EDGE PROTECTION. SEE USC DOCUMENT "GENERAL GUIDELINES COMMUNICATIONS INFRASTRUCTURE UNIVERSITY OF SOUTH CAROLINA REVISED 5/12". PROVIDE CABLING, JACKS, CONNECTIONS, FACEPLATES, LABELING AND TESTING. SPOT TYPE SMOKE DETECTOR, CEILING MOUNTED COMBINATION FIRE ALARM AUDIO/VISUAL INDICATING DEVICE. SEMI-FLUSH MOUNT

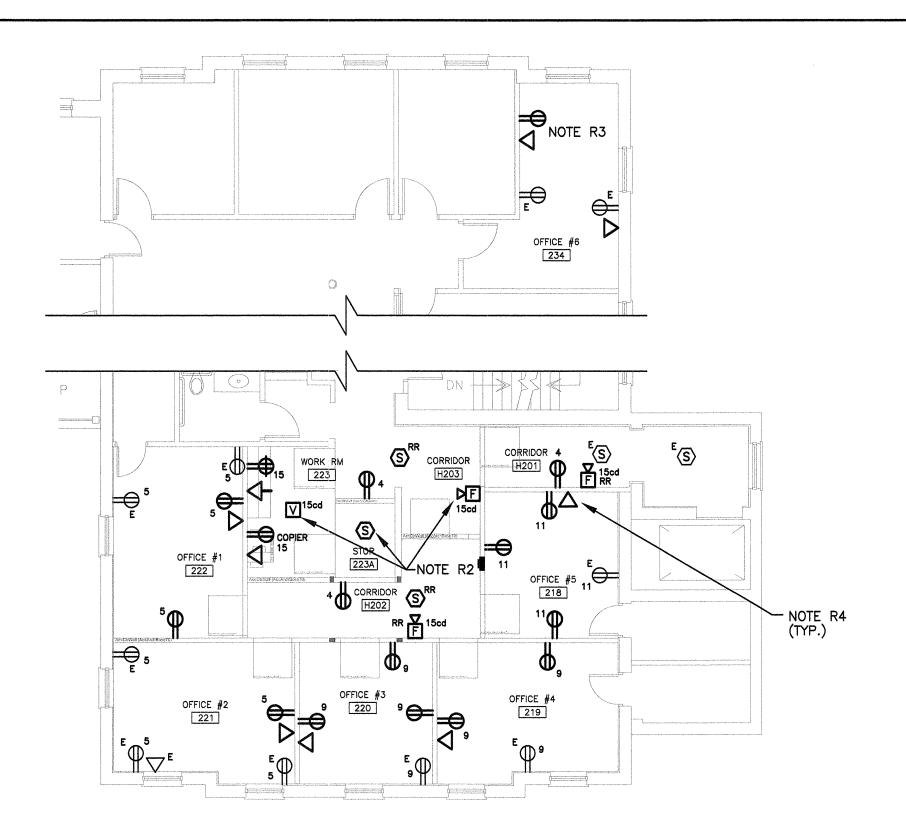

2 POWER & SYSTEMS RENOVATION PLAN


SCALE: 1/8" = 1'-0"

ELECTRICAL POWER RENOVATION NOTES

- R1. ALL RECEPTACLES SHALL BE FED FROM EXISTING PANEL "2P1" (SEE KEY PLAN FOR LOCATION). CIRCUIT NUMBERS SHOWN ARE DIAGRAMMATIC ONLY. ELECTRICAL CONTRACTOR SHALL FIELD VERIFY ALL CIRCUIT AVAILABILITY. ELECTRICAL CONTRACTOR SHALL PROVIDE NEW TYPED PANEL DIRECTORY.
- R2. PROVIDE NEW FIRE ALARM DEVICES AS INDICATED ON PLAN. EXTEND EXISTING FIRE ALARM CIRCUITS TO THESE NEW DEVICES. PROVIDE ADDITIONAL POWER SUPPLY AND PROGRAMMING IN EXISTING FIRE ALARM PANEL AS REQUIRED EXISTING FIRE PANEL IS A SIMPLEX 4020 LOCATED IN EXISTING 2ND FLOOR ELECTRICAL ROOM (SEE KEY PLAN FOR LOCATION).
- R3. EXTEND EXISTING RECEPTACLE CIRCUIT IN THIS ROOM TO NEW RECEPTACLE.
- R4. PROVIDE NEW VOICE/DATA STATIONS AS INDICATED ON PLAN. PROVIDE DATA CABLES FROM VOICE/DATA STATIONS TO EXISTING TELCOM BOARD LOCATED IN EXISTING 2ND FLOOR ELECTRICAL ROOM (SEE KEY PLAN FOR LOCATION).

ELECTRICAL GENERAL NOTES


- 1. ELECTRICAL LAYOUT DRAWINGS ARE DIAGRAMMATIC. COORDINATE ALL WORK WITH ARCHITECTURAL, AND MECHANICAL.
- 2. INSTALL THE ELECTRICAL SYSTEM WITHOUT INTERFERING WITH DUCTS, PIPES, STRUCTURAL STEEL, OR OTHER SYSTEMS.
- 3. LOCATE LIGHTING FIXTURES SYMMETRICALLY IN THE PROPER RELATION TO FINISHED AREAS.
- 4. PROVIDE ADDITIONAL SUPPORTS WHEREVER THE BUILDING STRUCTURE IS NOT SUITABLE FOR DIRECT MOUNTING. PROVIDE TWO #12 STEEL, SLACK CABLES TO STRUCTURE FROM EACH FIXTURE MOUNTED IN A GRID CEILING.
- 5. EMT FITTINGS SHALL BE OF THE COMPRESSION TYPE. SET—SCREW OR INDENTOR TYPE FITTINGS SHALL NOT BE USED.
- 6. PROVIDE FIRESTOPPING AROUND RACEWAYS PENETRATING RATED WALLS.
- 7. THIS SCOPE OF WORK SHALL COMPLY WITH NEC-2008.
- 8. ALL COMPONENTS SHALL BE LISTED AND LABELED, UL OR EQUAL THIRD PARTY INSPECTED.
- 9. SPOT TYPE SMOKE DETECTORS SHALL BE AT LEAST 36" FROM ANY HVAC DIFFUSER.
- 10. OUTLETS WHICH OCCUR ON OPPOSITE SIDES OF A COMMON WALL SHALL BE OFFSET A MINIMUM OF 6 INCHES.

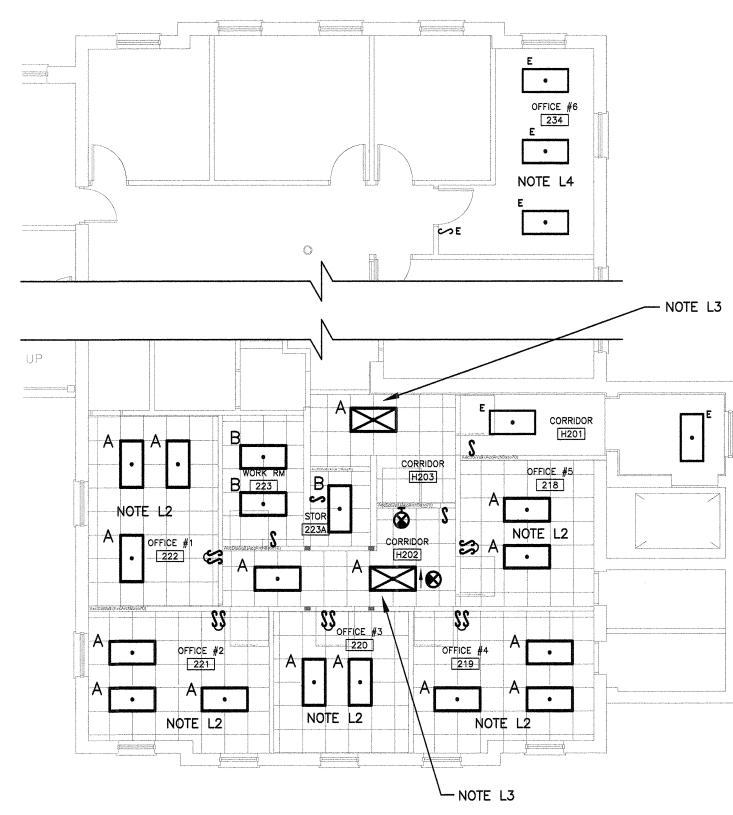

3 LIGHTING RENOVATION PLAN SCALE: 1/8" = 1'-0"

ELECTRICAL LIGHTING RENOVATION NOTES


- L1. ALL LIGHTING SHALL BE FED FROM EXISTING PANEL "2L1-ALT" (SEE KEY PLAN FOR LOCATION). RE-USE EXISTING LIGHTING CIRCUITS. ELECTRICAL CONTRACTOR SHALL FIELD VERIFY EXISTING CIRCUITS AND SHALL PROVIDE NEW TYPED PANEL DIRECTORY.
- L2. ONE SWITCH SHALL CONTROL ALL INBOARD LAMPS IN FIXTURES IN THIS ROOM AND OTHER SWITCH SHALL CONTROL ALL OUTBOARD LAMPS IN FIXTURES IN THIS ROOM.
- L3. PROVIDE BATTERY BACKUP IN THIS FIXTURE (LITHONIA #PS1400QD OR APPROVED EQUAL)
- L4. ELECTRICAL CONTRACTOR SHALL CLEAN AND RELAMP EXISTING 2'x4' TROFFERS IN THIS ROOM.

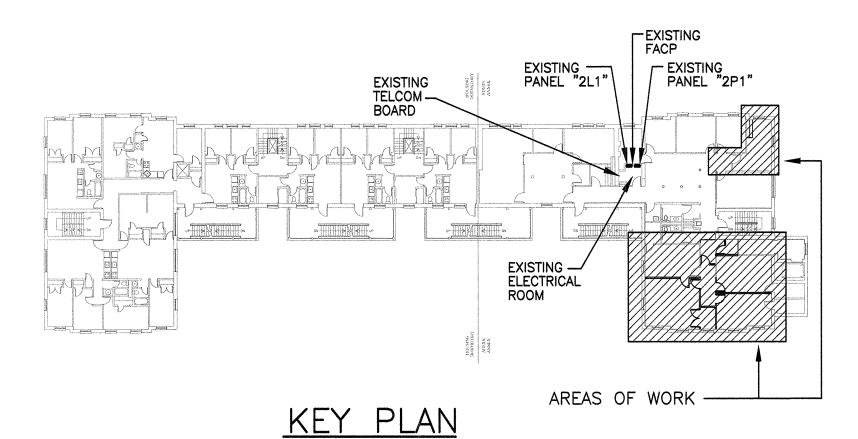

NOT TO SCALE

	LIGHTING FIXTURE SCHEDULE							
SYMBOL	TYPE	DESCRIPTION	MANUFACTURER	MODEL NUMBER	OPTICAL ELEMENT	MOUNTING	VOLTS	LAMPS (PHILIPS)
•	A RE-INSTALL EXISTING 2'x4' FLUORESCENT TROFFER. CLEAN AND RELAMP.					3 — F32T8/TL741/ALTO		
0	В	NEW 2'x4' FLUORESCENT AIR-HANDLING TROFFER FIXTURE	LITHONIA	2SPGA 332 A12125 MVOLT	.125 ACRYLIC LENS	GRID	277	3 — F32T8/TL741/ALTO
1⊗ ⊗	×	WALL MOUNTED EXIT SIGN SINGLE FACE, WITH NICad BATTERY	LITHONIA	LE S 1 R 120/277 EL N	NONE	MOUNTED AS SHOWN	277	LED — INCLUDED


NOTE: LAMP DESCRIPTIONS ARE PHILIPS CATALOG NUMBERS (UNLESS NOTED OTHERWISE) OR APPROVED EQUAL.

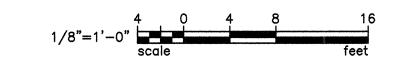




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NO. DATE TYPE BY



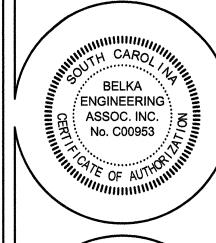

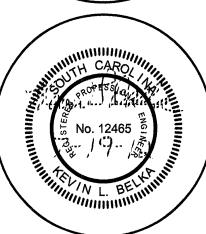RENOVATIONS

JUNE SITY OF SOUTH CAROLINA

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PAGE NAME

& RENOVATION PLANS

DESIGNED BY: KLB

DRAWN BY: ZES

CHECKED BY: KLB

DATE: 07/18/2012

SCALE: 1/8" = 1'-0"

JOB NO.: JB21201

E-1 of

MOUNTING HEIGHTS INDICATED IN THIS LEGEND SHALL BE TO CENTERLINE OF DEVICE BOX. ALL SWITCHES AND PULL STATIONS SHALL BE INSTALLED TO BE ADA—COMPLIANT (NOT GREATER THAN 48"AFF TO TOGGLE/LEVER).

FIRE ALARM VISUAL-ONLY INDICATING DEVICE. SEMI-FLUSH MOUNT UNIT IN

UNIT 80" AFF IN WALL. NUMBER INDICATES CANDELA RATING.

CEILING TILE. NUMBER INDICATES CANDELA RATING.